ST. LOUIS CATHOLIC HIGH SCHOOL MODULAR CAMPUS

1620 BANK ST. LAKE CHARLES, LA

INDEX OF SHEETS

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ELECTRICAL SITE PLAN
ELECTRICAL RISER DIAGRAMS


FA2.0 FIRE ALARM/ INTERCOM/ SECURITY CAMERA SITE PLAN

P1.0 PLUMBING SITE PLAN P2.0 PLUMBING DETAILS

MODULAR BUILDING - TYPE "A"
MODULAR BUILDING - TYPE "B"
MODULAR BUILDING - TYPE "C"
MODULAR BUILDING - TYPE "D"
MODULAR BUILDING - TYPE "E"

PROJECT SITE



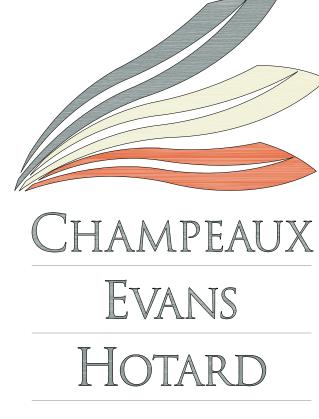

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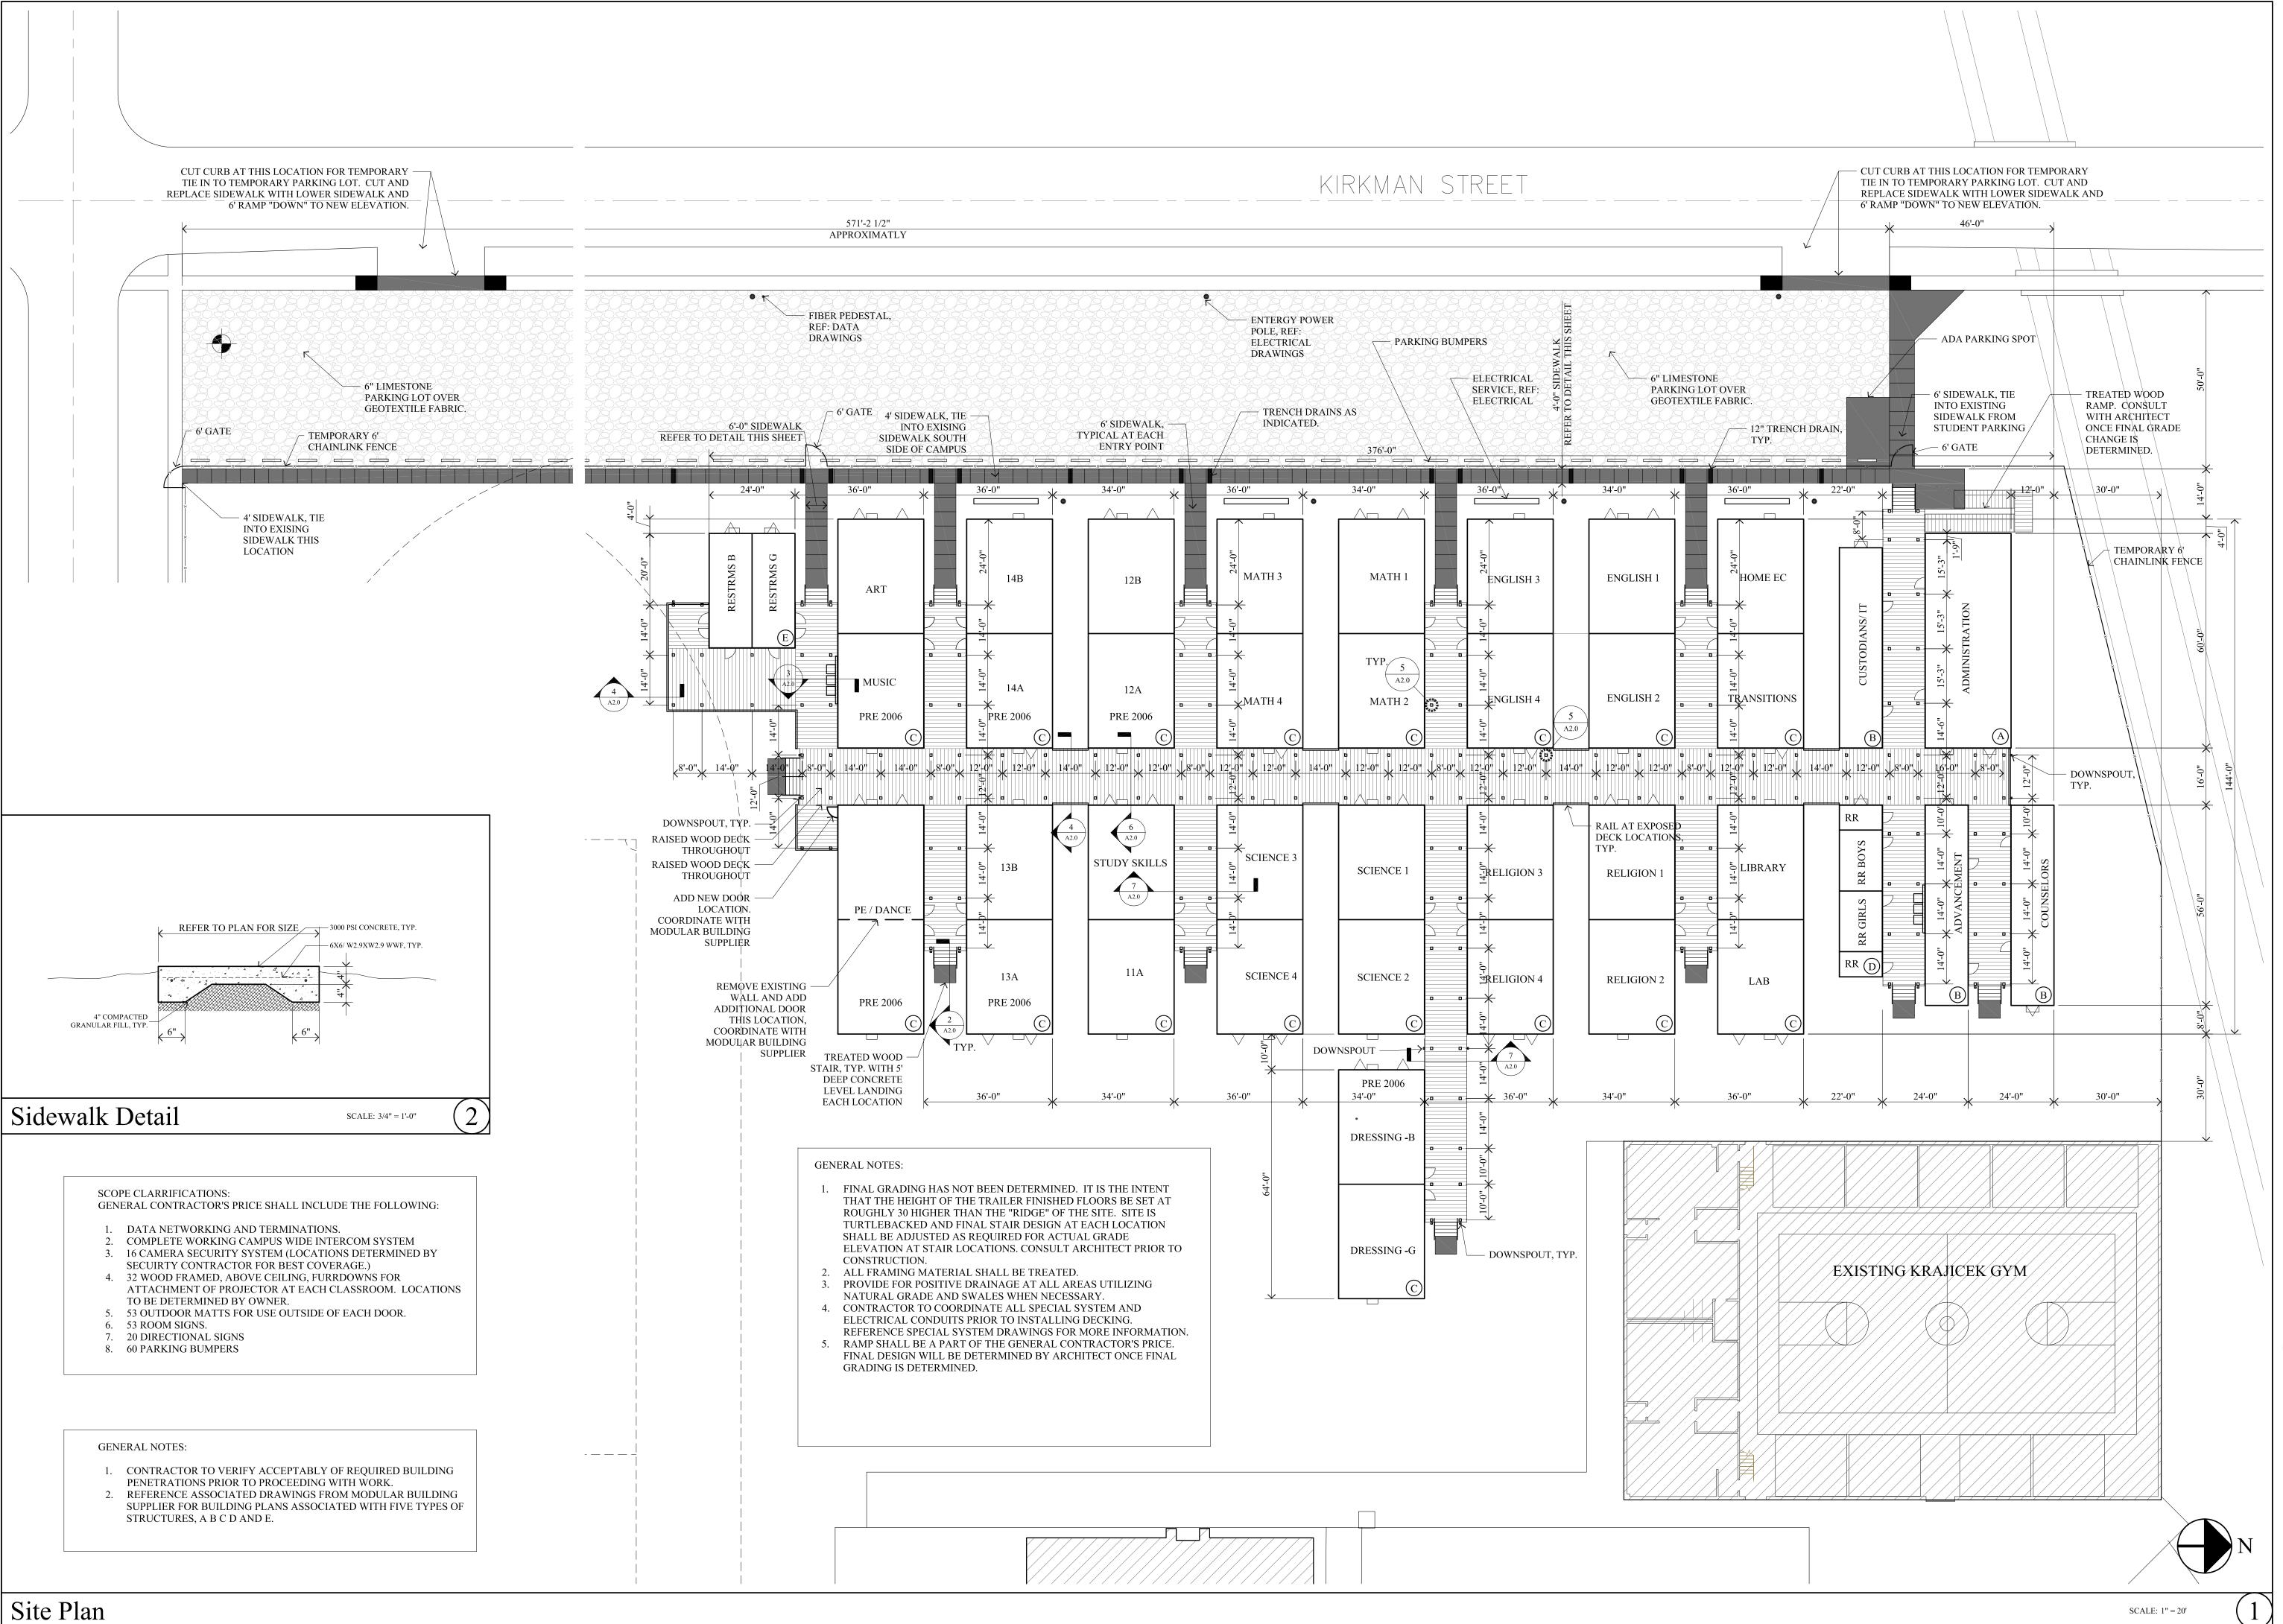
Consultants





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High School

Modular Campus

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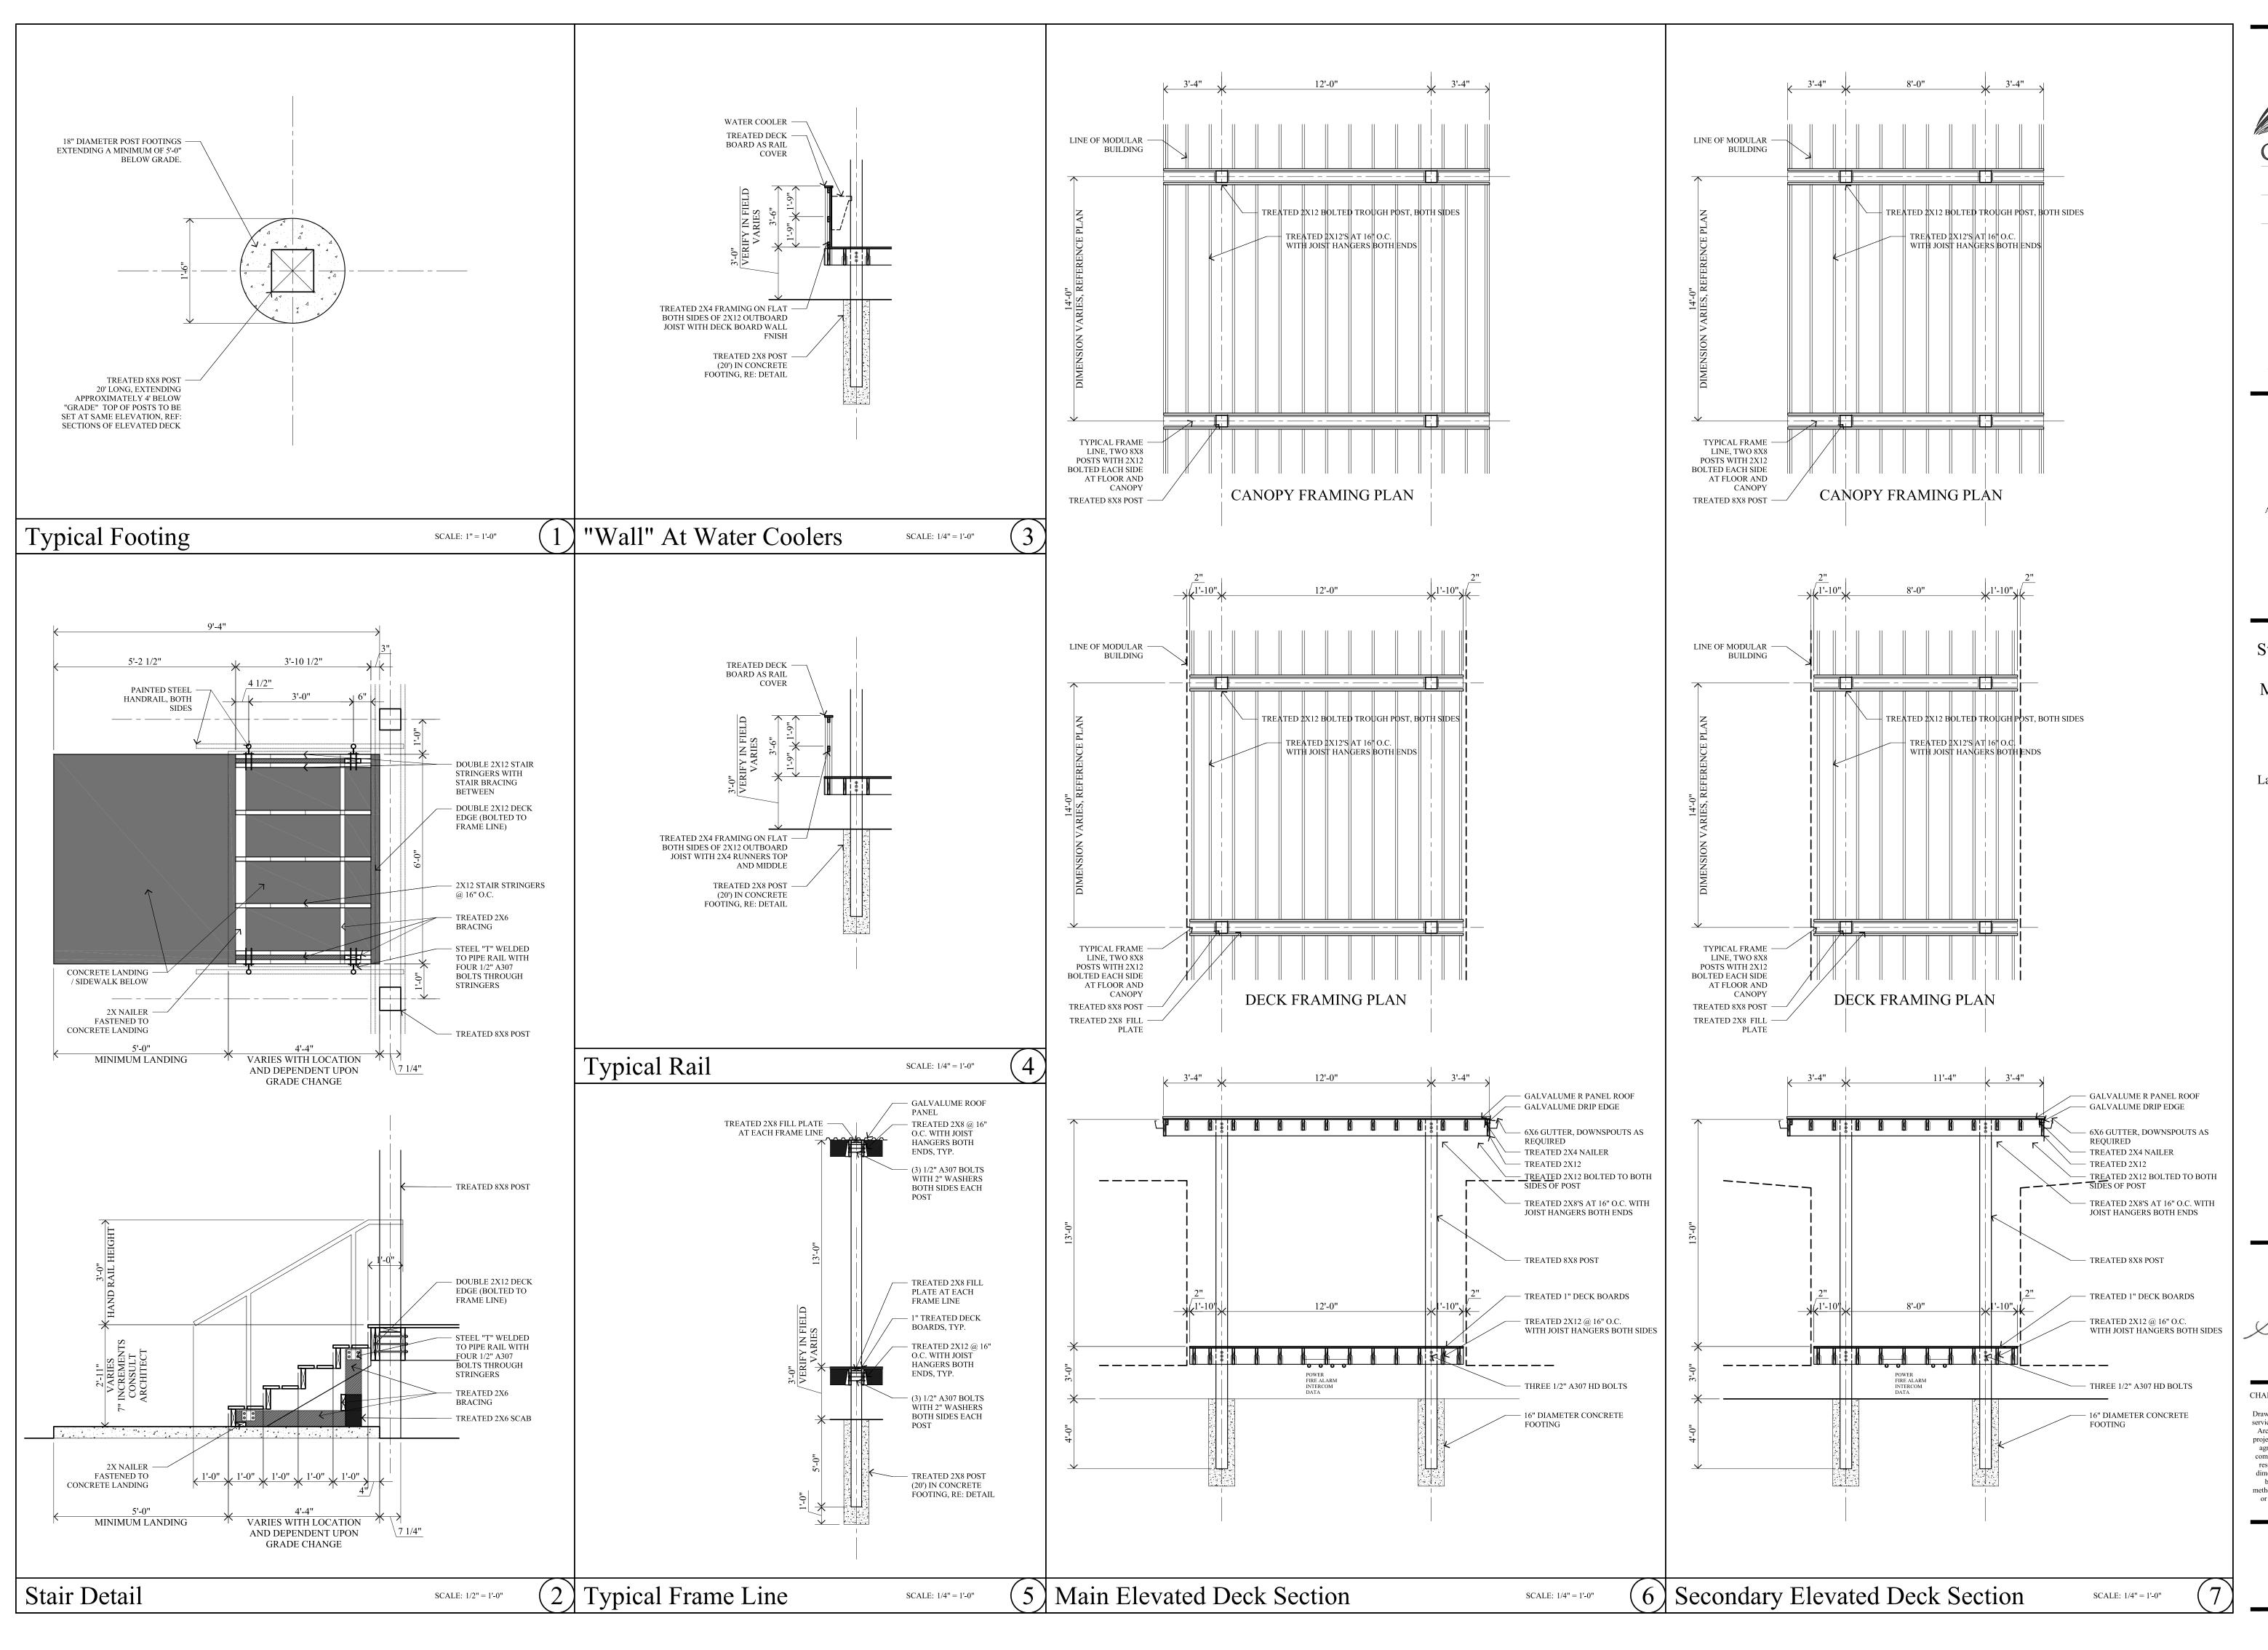


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09/14/2020



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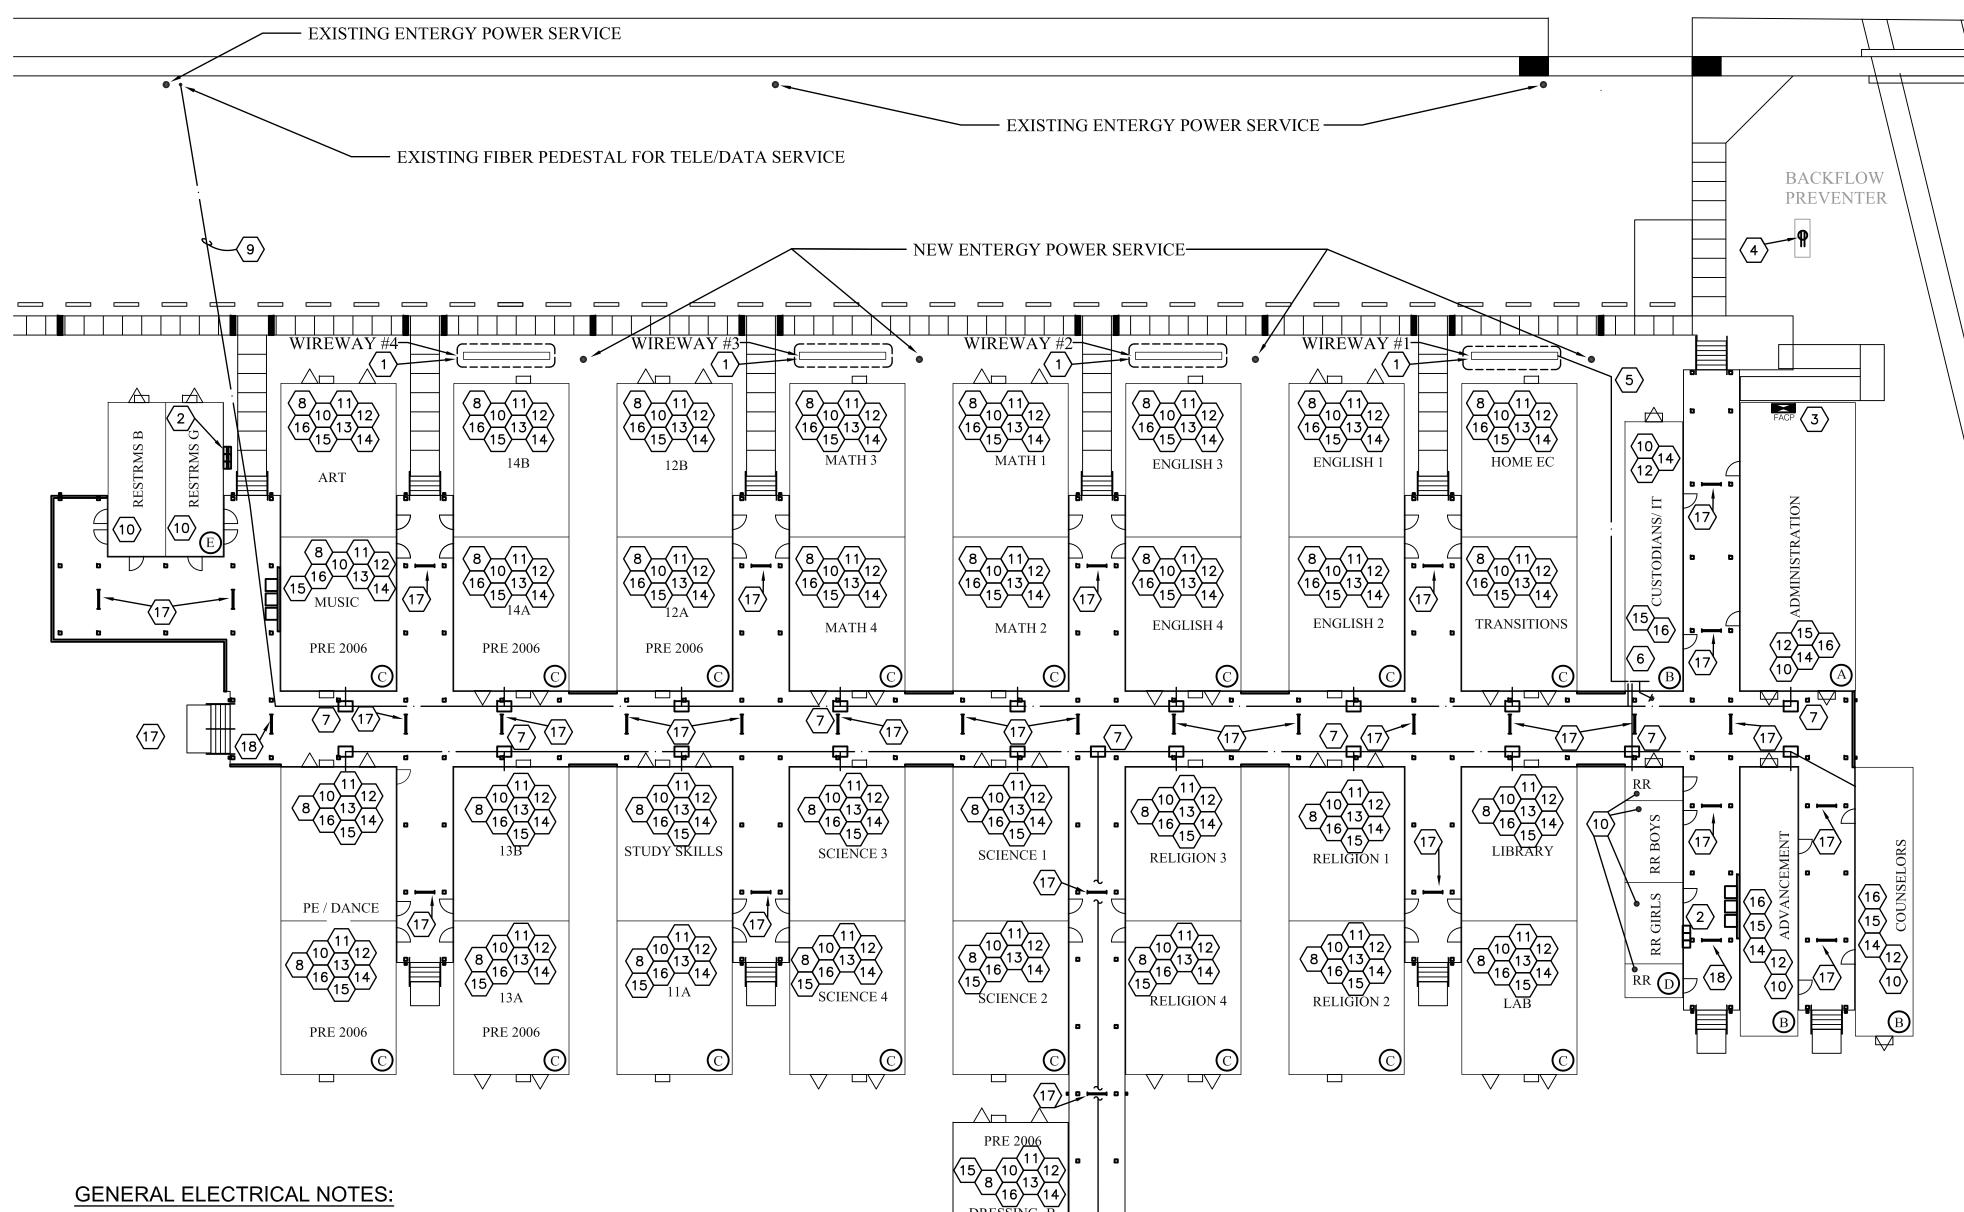
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A2.0

connection with the project.

PRINT DATE 09/14/2020

KIRKMAN STREET



DRESSING-G

ELECTRICAL KEYNOTES:

- (1) SEE SHEET E2.0 FOR DISCONNECT LAYOUT ON RISER DIAGRAM. CONDUITS SHALL BE RUN FROM EACH DISCONNECT BELOW RAISED DECK TO TERMINATION POINT AT RESPECTIVE PORTABLE BUILDING. SEE SAFETY SWITCH SCHEDULE ON THIS SHEET FOR ALLOCATION OF LABELED DISCONNECTS TO APPROPRIATE PORTABLE BUILDING. CONTRACTOR SHALL COORDINATE TERMINATION REQUIREMENTS WITH PORTABLE BUILDING MANUFACTURER PRIOR TO ROUGH IN.
- INSTALL A WEATHERPROOF RECEPTACLE INSIDE THE FRAME OF EACH WATER COOLER, EXTEND #12 THHN, #12G, 1/2"C FROM EACH OF THE THREE WATER COOLERS TO A NEW 20 AMP GFI CIRCUIT BREAKER IN NEAREST PORTABLE BUILDING PANEL.
- (3) EXTEND #12 THHN. #12G. 1/2"C FROM FIRE ALARM CONTROL PANEL TO A NEW 20 AMP CIRCUIT BREAKER IN NEAREST PORTABLE BUILDING PANEL. CIRCUIT BREAKER SHALL BE RED AND BE PROVIDED WITH A BREAKER LOCK IN THE "ON" POSITION.
- 4 PROVIDE A WEATHERPROOF RECEPTACLE ON A FREE STANDING RACK INSIDE BACKFLOW PREVENTER ENCLOSURE. EXTEND #10 THHN, #10G, 3/4"C FROM BACKFLOW PREVENTER HEATER RECEPTACLE TO A NEW SINGLE 20 AMP CIRCUIT BREAKER IN PANEL HP.
- (5) INSTALL TWO 2" CONDUITS WITH PULL STRINGS FROM SERVICE RACK TO DATA/COM RACK IN I.T. ROOM.
- $\langle 6 \rangle$ COORDINATE LOCATION OF DATA/COM RACK WITH OWNER PRIOR TO ROUGH IN. PROVIDE GROUND BAR PER DETAIL ON SHEET E3.0. CONNECT GROUND BAR TO MAIN SERVICE GROUND.
- (7) EXTEND ONE 2" CONDUIT BELOW THE ELEVATED WALKWAY FROM THE I.T. RACK TO EACH ROW (2 ROWS TOTAL) OF BUILDINGS. INSTALL A 12"X12"X6" DEEP NEMA 3R JUNCTION BOX BELOW THE ELEVATED WALKWAY FROM THE I.T. RACK AT EACH BUILDING. (TYPICAL)
- (8) INSTALL 2" CONDUIT (BY THE ELECTRICIAN) INSTALLED IN THE BACK CORNER OF EACH CLASSROOM CLOSET EXTENDING UP 12" ABOVE FINISHED FLOOR.
- (9) 2" CONDUIT (BY THE ELECTRICIAN) INSTALLED FROM THE PEDESTAL ON SITE AT KIRKMAN. TO BETWEEN THE ART AND RESTROOM TRAILER UNDERNEATH THE DECK. FROM THERE IT WILL RUN EXPOSED. PEDESTAL IS CURRENTLY LOCATED ON THE EAST SIDE OF SIDEWALK ROUGHLY LINED UP WITH THE CENTERLINE OF THE DOUBLE WIDE RESTROOM TRAILER.
- (10) INSTALL AN OUTLET WITHIN THE CLOSETS AT EACH TRAILER (BY THE ELECTRICIAN) TO PROVIDE POWER TO NETWORK SWITCH.CONNECT TO NEAREST AVAILABLE PANEL USING #12 THHN, #12 GROUND, 1/2"C.

- (11) OUTLET INSTALLED (BY THE ELECTRICIAN) WITHIN THE ABOVE CEILING SPACE AT EACH CLASSROOM FOR THE CEILING MOUNTED PROJECTOR. CONNECT TO NEAREST AVAILABLE PANEL USING #12 THHN, #12 GROUND, 1/2"C. GENERAL CONTRACTOR TO PROVIDE DROP DOWN FRAMING ABOVE CEILING TO MOUNT ONE OVERHEAD PROJECTOR AT EACH CLASSROOM, (32 CLASSROOMS TOTAL.).
- DATA CONTRACTOR SHALL PROVIDE ALL FIBER AND RG5/6 CABLES AND APPROPRIATE HARDWARE TO RUN, MOUNT AND CONNECT 8 DATA DROPS AT EACH CLASSROOM TRAILER (16 TRAILERS TOTAL) AND ASSOCIATED SWITCH AND WIRELESS ACCESS POINT AND 16 DATA DROPS AT EACH "OFFICE" TRAILER (4 TRAILERS TOTAL) AND ASSOCIATED SWITCH AND WIRELESS ACCESS POINT.
- $\langle 13 \rangle$ OWNER TO PROVIDE PROJECTORS AND MOUNTING HARDWARE AS WELL AS WIRELESS ACCESS POINTS.
- \langle 14angle $\,$ IT IS CURRENTLY THE INTENTION THAT ALL DATA CABLING AND FIBER WILL BE RUN "EXPOSED" AND STRAPPED TO THE FLOOR JOISTS BETWEEN BUILDINGS. NO CONDUIT REQUIRED. CABLING SHALL BE RATED FOR EXTERIOR AND WET APPLICATIONS.
- DATA CONTRACTOR SHALL COORDINATE WITH OWNER FOR FINAL DATA DROP LOCATIONS WITHIN EACH TRAILER. SUBMIT DRAWING FOR
- DATA CONTRACTOR TO PROVIDE ONE SWITCH PER TRAILER AND TWO AT TOP-OF-RACK (22 TOTAL) (NOT AT RESTROOMS). SWITCHES SHALL BE MODEL #'S (TP-LINK TL-SG1218MPE WITH TL-SM311LSV4 INTERFACE MODULE) AT CLASSROOMS AND AT EACH OFFICE TRAILER.
- PROVIDE AND INSTALL 4' VAPORTITE LED FIXTURE (LITHONIA: XVML-L48-3500LM-MVOLT-40K-80CRI). CONNECT TO CIRCUIT #2 ON PANEL HP USING #12 THHN, #12 GROUND, 1/2"C. CONTROL VIA PHOTOCELL & TIMECLOCK CONNECTED TO PANEL HP.

Evans

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PANEL VOLTAGE ☐ 120/208V, 1ø, 3W ☐ 120/240V, 1ø, 3W

NEUTRAL **■** 100% **□** 200%

SAFETY SWITCH SCHEDULE

120/240 2

120/240 2

120/240 2 HEAVY

120/240 2 | HEAVY |

120/240 2 HEAVY

120/240 | 2 | HEAVY

120/240 2 | HEAVY |

120/240 2 HEAVY

120/240 2 | HEAVY |

120/240 2 | HEAVY |

120/240 2 HEAVY

120/240 2 | HEAVY |

120/240 2 HEAVY

120/240 2 HEAVY

120/240 2 | HEAVY |

DUTY | NEMA | FUSE

3R | 100

3R | 200

3R | 200

3R | 200

3R | 100

3R | 200

POLES | LISTING | RATING | SIZE

HEAVY

120/240 2 | HEAVY | 3R | 100

120/240 2 | HEAVY | 3R | 200

120/240 | 2 | HEAVY | 3R | 200

120/240 2 | HEAVY | 3R | 200

HEAVY

AMPERAGE VOLTAGE

100

200

200

200

100

200

200

RATING RATING

EQUIPMENT

ADMINISTRATION 3

CUSTODIANS/IT *

- Transitions ³

- COUNSELORS

ADVANCEMENT *

- RESTROOMS *

10- RELIGION 2 *

1- RELIGION 4 *

12- DRESSING G *

13- SCIENCE 2 * |

ENGLISH 2

- ENGLISH 4

SERVED

9- LAB

15- 11A

16- 13A

20- 12A

21- 14A

17- PE/DANCE

18- MATH 2

19- MATH 4

23- RESTROOMS * | 200

* SERVICE ENTRANCE RATED

ENCLOSURE ☐ NEMA 1 (TOOL-LESS

DOOR-IN-DOOR CONSTRUCTION) NEMA 3R ☐ NEMA 4X 320 STAINLESS STEEL LOCKABLE COVER

☐ SERIES RATED FURNISH GROUND BAR KI ☐ FURNISH ADDITIONAL ISOLATED GROUND BAR KIT SERVICE ENTRANCE LABEL

■ FULLY RATED

AIC RATING 22,000

■ BOLT-ON, PANELBOARD CONSTR. $oxedsymbol{\square}$ FUSIBLE SWITCHES, FURNISH ALL FUSES, RK5

■ TOP ■ BOTTOM

MOUNTING ■ SURFACE □ RECESSED FREE STANDING (FRONT ACCESS ONLY) ☐ FREE STANDING (FRONT AND REAR ACCESS)

☐ UL LISTED FEED—THRU LUGS


MAIN LUGS ONLY

SHUNT TRIP MAIN CB

☐ PLUG-ON, LOADCENTER CONSTR. ALL COPPER BUSSING

						•			•						
CKT.	TRIP AMPS	WIRE	GND	COND.	LOAD DESCRIPTION	NOTES	А	В	NOTES	LOAD DESCRIPTION	COND.	GND	WIRE	TRIP AMPS	CKT #
1	20	12	12	1/2	BACKFLOW PREVENT			$\overline{}$		LIGHTING	1/2"	12	12	20	2
3	20	_	_	_	SPARE		$\vdash \smallfrown \vdash$	$+ \sim$		SPARE	_	_	_	20	4
5	20	_	_	_	SPARE		├ ^┿	$+ \sim$		SPARE	_	_	_	20	6
7	20	_	_	_	SPARE		$\vdash \smallfrown \vdash$	$+ \sim$		SPARE	_	_	_	20	8
9	20	_	_	_	SPARE		$\vdash \smallfrown \downarrow$	$+ \sim$		SPARE	_	_	_	20	10
11	20	_	_	_	SPARE		$\vdash \smallfrown \vdash$	$+ \sim$		SPARE	_	_	_	20	12
13	20	_	_	_	SPARE		$\vdash \smallfrown \downarrow$	$+ \sim$		SPARE	_	_	_	20	14
15	20	_	_	_	SPARE		$\vdash \smallfrown \vdash$	$+ \sim$		SPARE	_	_	_	20	16
17	20	_	_	_	SPARE		$\vdash \smallfrown \downarrow$	$+ \sim$		SPARE	_	_	_	20	18
19	20	_	_	_	SPARE		$\vdash \smallfrown \vdash$	$+ \sim$		SPACE	_	_	_	_	20
21	_	_	_	_	SPACE		$\vdash \smallfrown \downarrow$	$+ \sim$		SPACE	_	_	_	_	22
23	_	_	_	_	SPACE		$\vdash \smallfrown \vdash$	$+ \sim$		SPACE	_	_	_	_	24
25	_	_	_	_	SPACE		$\vdash \smallfrown \downarrow$	$+ \sim$		SPACE	_	_	_	_	26
27	_	_	_	_	SPACE		$\vdash \smallfrown \vdash$	$+ \sim$		SPACE	_	_	_	_	28
29	_	_	_	_	SPACE		$\vdash \smallfrown \downarrow$	$+ \sim$		SPACE	_	_	_	_	30
NOT	ES:										TO.	TAL LO	VD =	10	1/1/4

PROJECT NUMBER

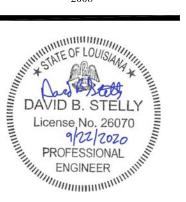

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ELECTRICAL SITE PLAN

A. COORDINATE EXACT MOUNTING HEIGHTS OF ALL

DEVICES WITH ARCHITECT/OWNER PRIOR TO

B. COMPLETE CONNECTIONS TO ALL EQUIPMENT AND

REQUIRED FOR SECURE INSTALLATIONS.

C. CONTRACTOR SHALL REFER TO ARCHITECTURAL

PLANS FOR LOCATIONS OF ANY AND ALL RATED

ASSEMBLIES AND EXTERIOR WALLS AND SHALL

PROPERLY SEAL ALL PENETRATIONS TO THE

RATING(S) OF THE ASSEMBLIES AND BUILDING

THOROUGHLY FAMILIARIZE THEMSELVES WITH THE

EXISTING CONDITIONS VERIFYING THAT THE WORK

DEMOLITION DRAWINGS, PRIOR TO SUBMITTING A

SHALL LOCATE ALL WORK TO REMAIN, INCLUDING,

ELECTRICAL, STRUCTURAL AND ARCHITECTURAL

DURING DEMOLITION AND NEW CONSTRUCTION.

THE CONTRACTOR SHALL AT ALL TIMES CONSULT

WITH THE ARCHITECT AND FOLLOW DIRECTIVES

ISSUED BY THE ARCHITECT WHICH WILL ENSURE

OWNERS OPERATIONS. THE CONTRACTOR SHALL

OPERATIONS AT ALL TIMES AND SHALL NOTIFY THE

OPERATION OF THE OWNER AT LEAST THREE DAYS

THE CONTINUED SAFE FUNCTIONING OF THE

MINIMIZE ENCUMBRANCES TO THE OWNER'S

ARCHITECT OF ANY WORK AFFECTING THE

G. THE CONTRACTOR SHALL VERIFY ALL DIMENSIONS

PRIOR TO COMMENCING CONSTRUCTION. ANY

DISCREPANCIES SHALL BE BROUGHT TO THE

CLARIFICATION. DIMENSIONS AND CONDITIONS

PRIOR TO PERFORMING SAID WORK.

ATTENTION OF THE ARCHITECT FOR

AND SHALL PROTECT SUCH WORK FROM DAMAGE

CAN BE PERFORMED AS DESCRIBED IN THESE

E. PRIOR TO COMMENCING WORK, THE CONTRACTOR

BUT NOT LIMITED TO PLUMBING, HVAC,

ASSEMBLIES AND WALLS SUCH THAT THE

D. THE CONTRACTOR SHALL VISIT THE SITE AND

ENVELOPE ARE MAINTAINED.

REQUIREMENTS PRIOR TO ROUGH-IN.

PROVIDE PROPER CONDUIT SUPPORTS/STRAPS

COORDINATE EXACT LOCATION AND CONNECTION

ELECTRICAL CODE.

TYING INTO OR GOVERNED BY EXISTING

PURPORTED TO BE CORRECT. ALL SUCH

VERIFIED BY THE CONTRACTOR PRIOR TO

H. THE CONTRACTOR SHALL ASK FOR DETAILS

I. CONTRACTOR SHALL REFER TO ALL OTHER

(PLANS, SPECIFICATIONS, ADDENDA,

PORTIONS OF THE CONTRACT DOCUMENTS

AND ANY APPROVED CHANGE ORDERS) AND

PROVIDE ALL LIGHT FIXTURES, OUTLETS,

ELECTRICAL PLANS. IF THERE ARE ANY

OR ORDERING MATERIALS.

CONDITIONS ARE APPROXIMATE AND ARE NOT

DIMENSIONS AND CONDITIONS SHALL BE FIELD

PERFORMING WORK, PREPARING SHOP DRAWINGS,

AND/OR INSTRUCTIONS WHEN UNCERTAIN HOW TO

PROCEED. THE LACK OF NOT REQUESTING DETAILS

DOES NOT EXCUSE SLOPPY OR IMPROPER WORK.

CORRECTION SHALL BE THE RESPONSIBILITY OF

THE CONTRACTOR AT NO COSTS TO THE OWNER.

ARCHITECTURAL SUPPLEMENTAL INSTRUCTIONS

TELE/DATA OUTLETS, SPEAKERS, AND ASSOCIATED

ORDERING EQUIPMENT, ROUGH-IN FOR EQUIPMENT

ROUGH-IN OF EQUIPMENT, CONTRACTOR SHALL BE

APPROVED SHOP DRAWINGS OF SUCH EQUIPMENT

AND REVIEWING SAID SUBMITTALS TO ENSURE

COMPATIBILITY WITH THE ELECTRICAL SYSTEM.

ROUGH-IN REQUIREMENTS AND THE ELECTRICAL

COMPLY WITH THE 2017 EDITION OF THE NATIONAL

AND/OR INSTALLATION OF EQUIPMENT. PRIOR TO

CIRCUITRY AS IF ORIGINALLY INCLUDED ON THE

DISCREPANCIES, CONTRACTOR SHALL NOTIFY

ARCHITECT/ENGINEER IN WRITING PRIOR TO

RESPONSIBLE FOR OBTAINING COPIES OF

CONTRACTOR SHALL IMMEDIATELY NOTIFY

ARCHITECT/ENGINEER IN WRITING OF ANY


DISCREPANCIES BETWEEN THE REQUIRED

J. AS A MINIMUM, ALL ELECTRICAL WORK SHALL

SCALE: 1'' = 20'-0''

TOTAL LOAD = 4.8 KVA

TOTAL AMPS = 20 AMPS

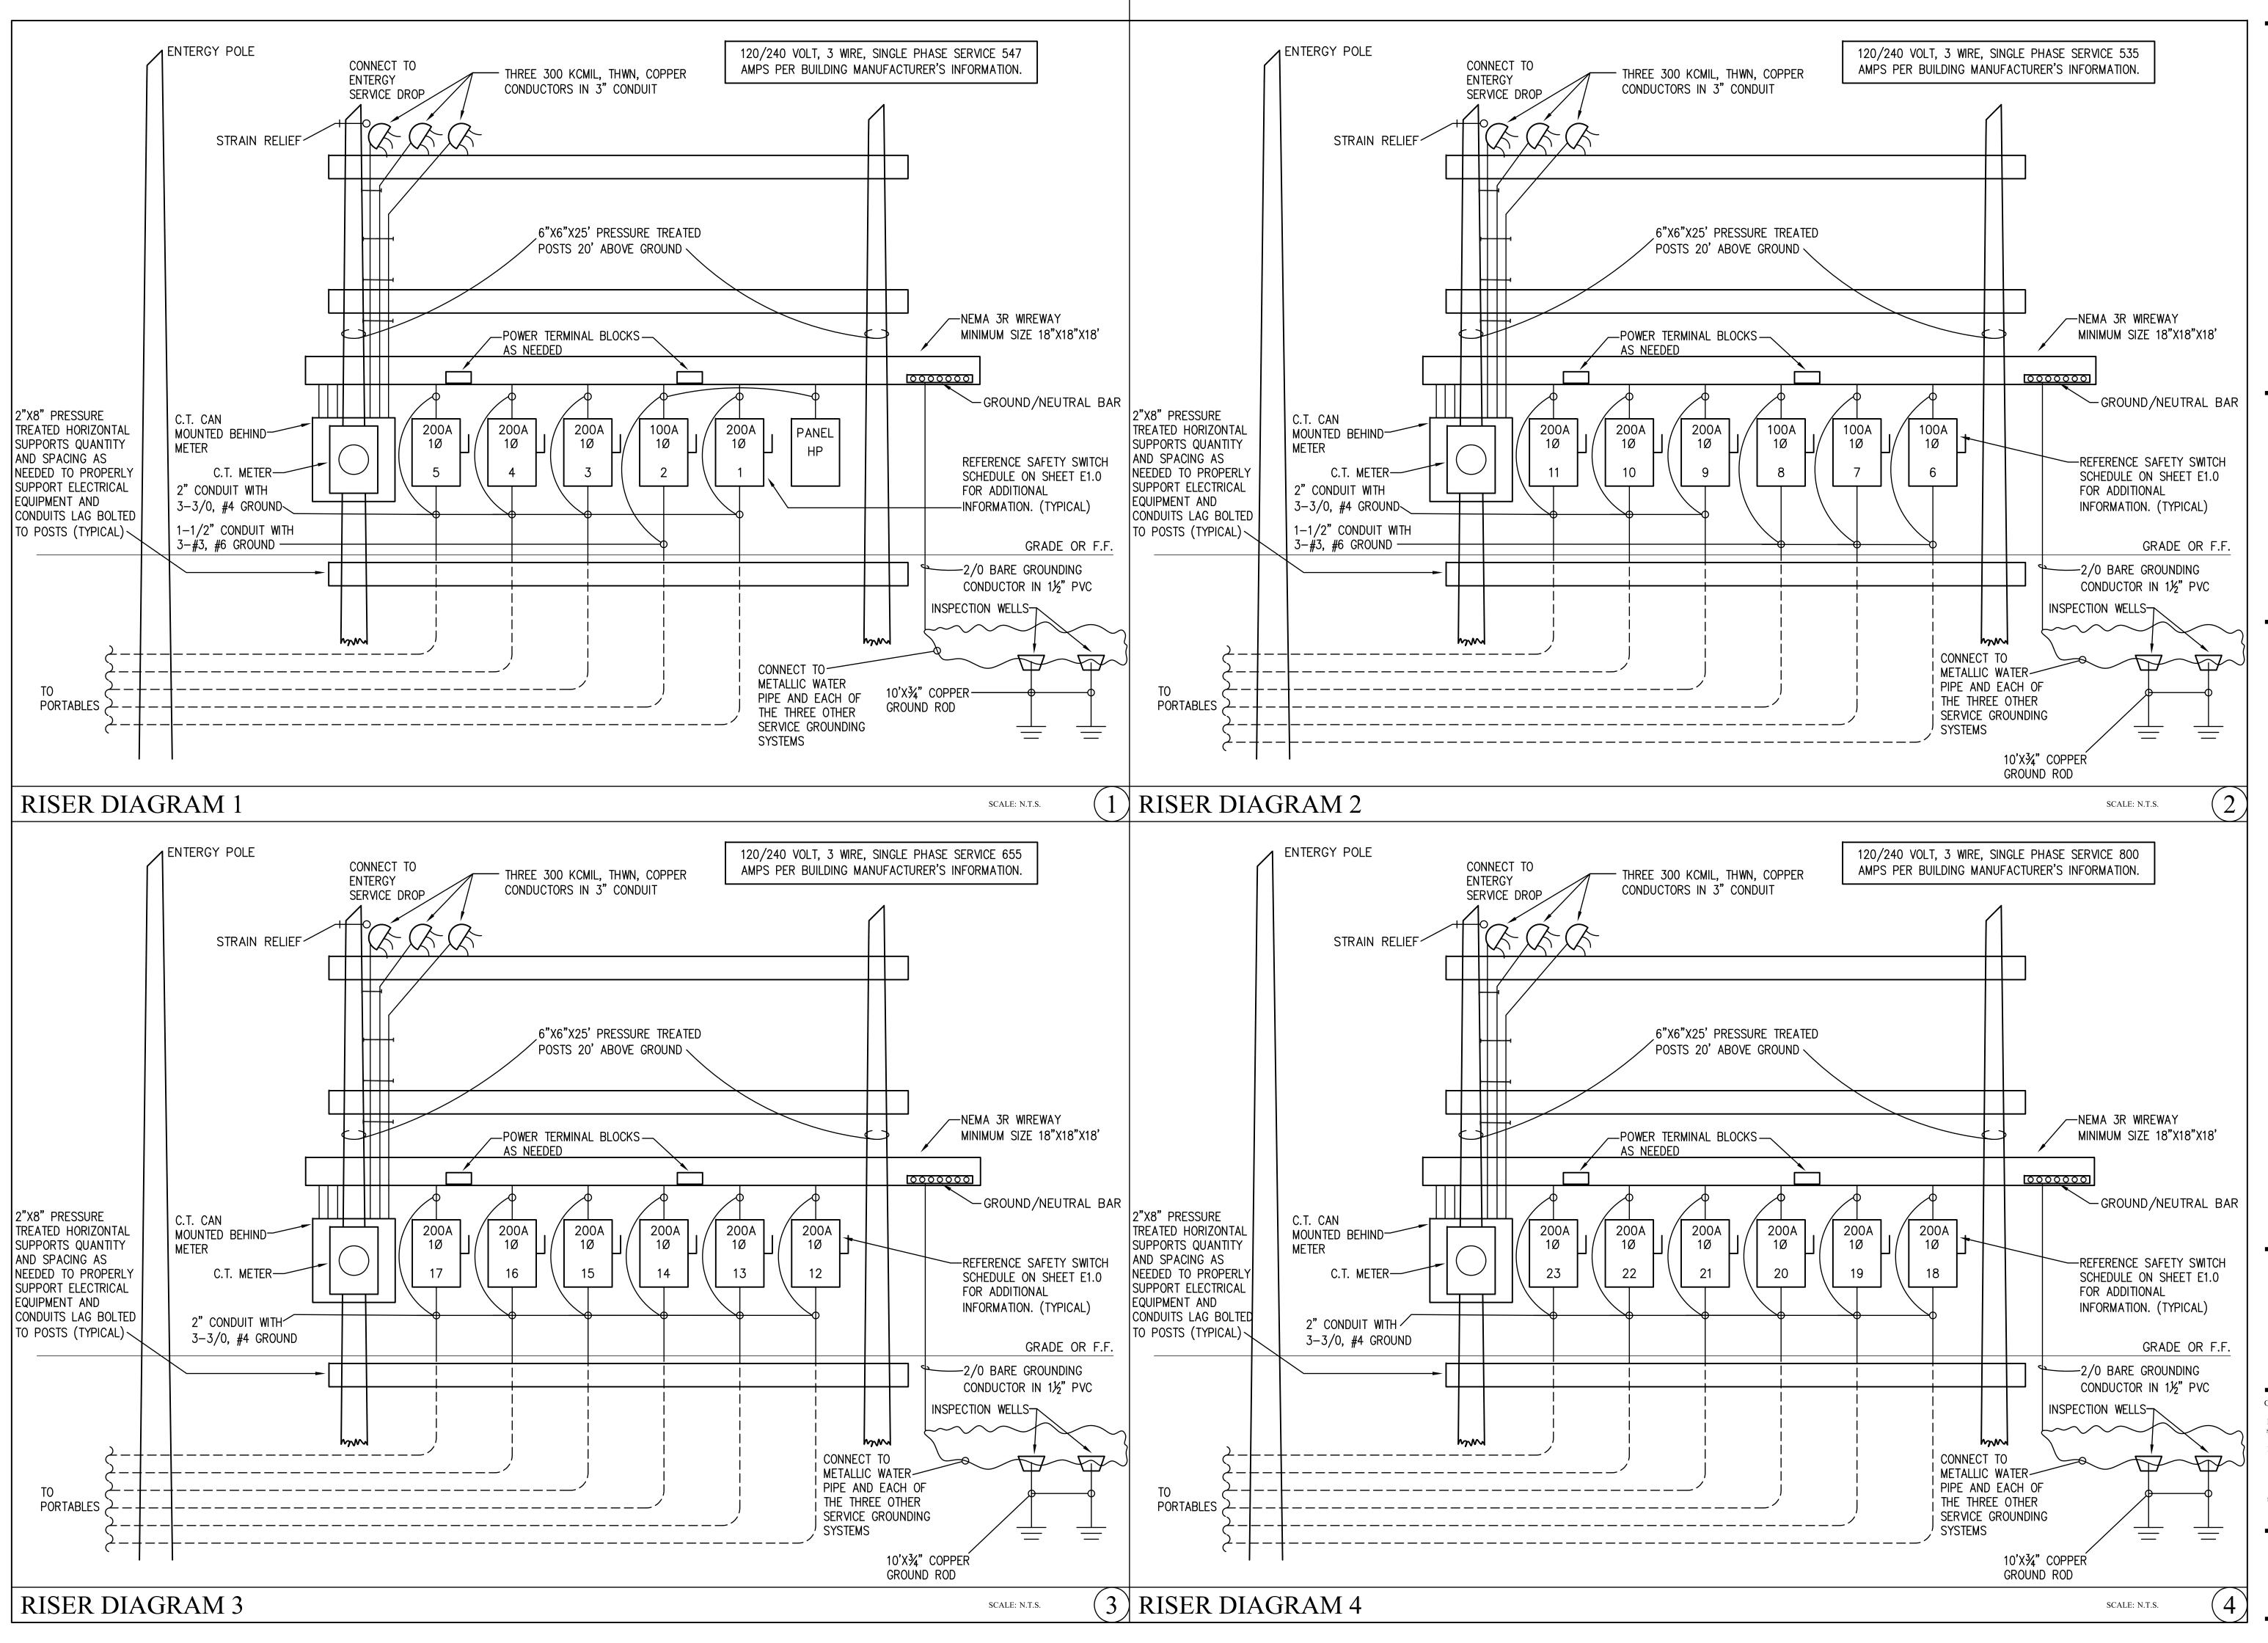



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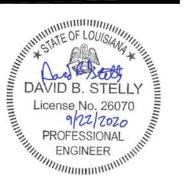


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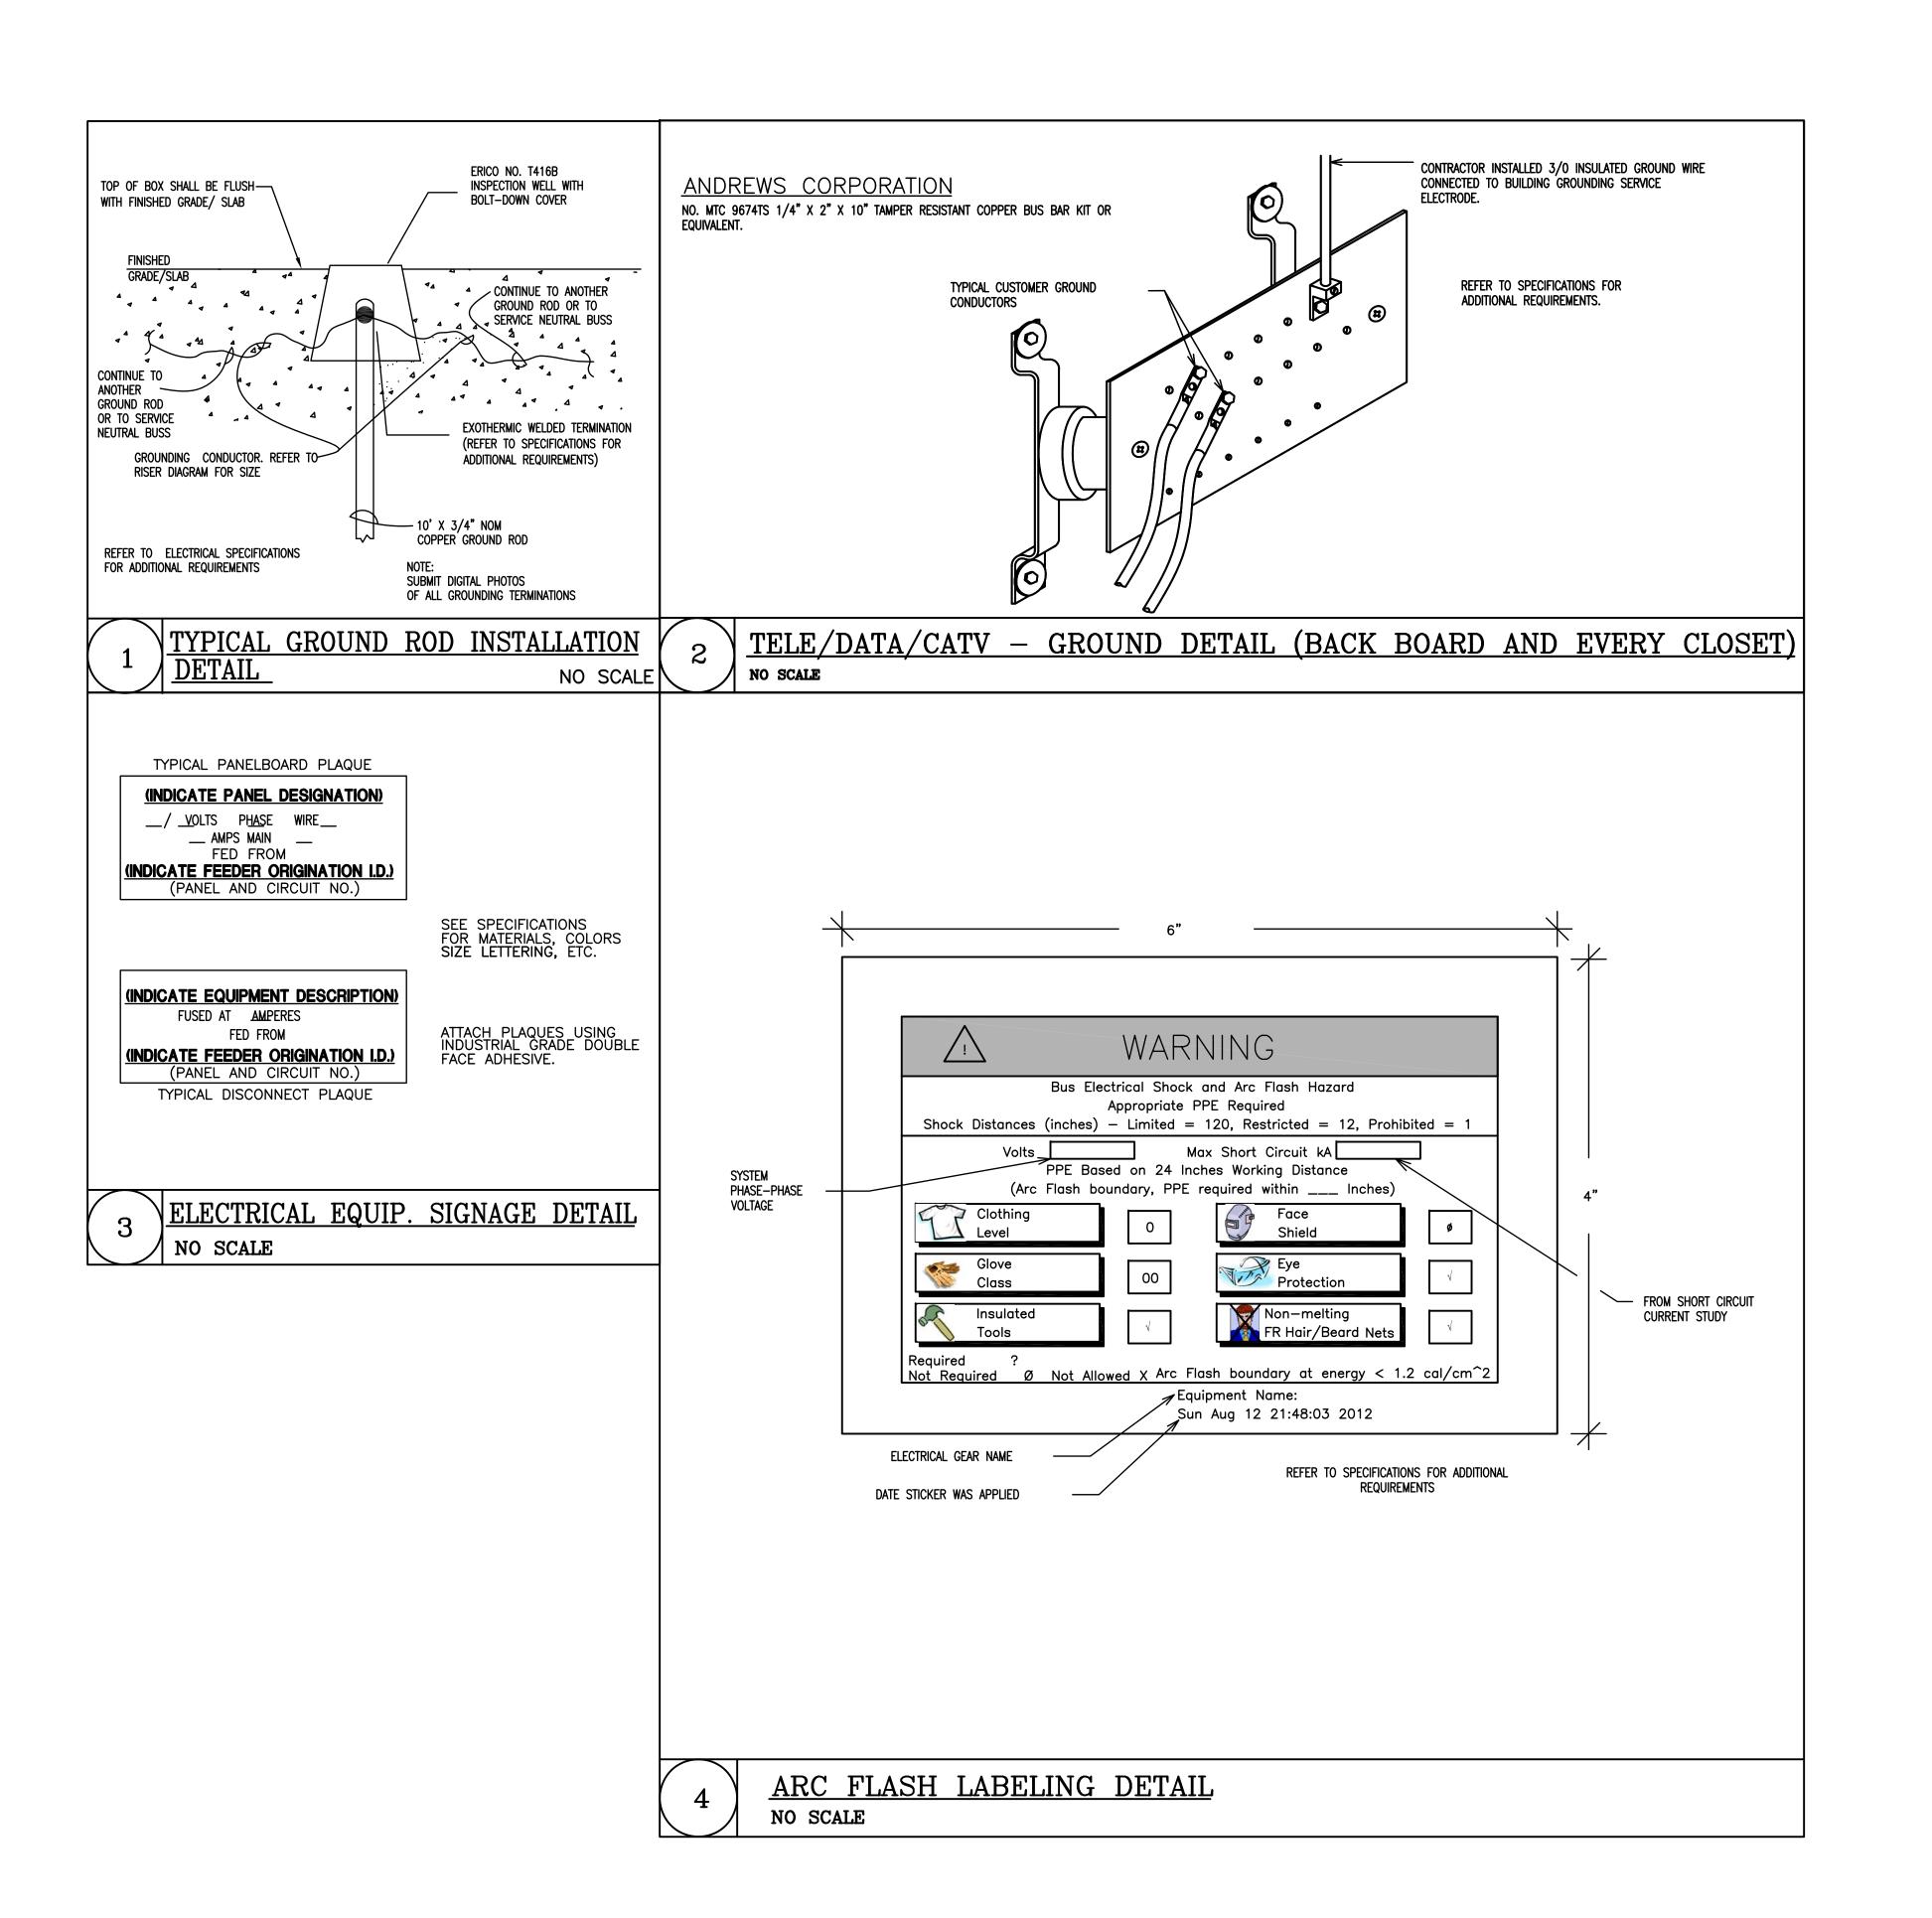
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E2.0

PRINT DATE 09/19/2020



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> PROJECT NUMBER 2008



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E3.0

PRINT DATE 09/19/2020

KRAJICEK GYM

TRANSITIONS ENGLISH 2 PRE 2006 PRE 2006 PRE 2006 SCIENCE 3 SCIENCE 1 RELIGION 1 PE / DANCE STUDY SKILLS SCIENCE 2 PRE 2006 DRESSING -G Ф

FIRE ALARM GENERAL NOTES:

INDICATING CIRCUIT LAYOUT SHALL BE BASED ON 1.5 AMP PER INDICATING CIRCUIT. AVAILABLE NUMBER AND LAYOUT OF CIRCUITS MAY BE REVISED UPON APPROVAL OF THE ENGINEER IF AVAILABLE INDICATING APPLIANCE POWER PER CIRCUIT DIFFERS FROM THE 1.5 AMP UTILIZED IN DESIGN. HOWEVER, THE DESIGN SHALL NOT RESULT IN A LOAD GREATER THAN (80) EIGHTY PERCENT OF THE AVAILABLE POWER FOR THE ALARM INDICATING CIRCUIT.

ALL WIRE/CABLE FOR INITIATING AND INDICATING CIRCUITS SHALL COMPLY WITH NFPA 70 ARTICLE 760. ALL WIRE SHALL BE RUN IN CONDUIT, WHERE WIRE IS SUBJECT TO DAMAGE, WHICH SHALL BE RUN IN NEAT AND ORDERLY MANNER AS HIGH AS POSSIBLE.

CONNECTION TO 120 VOLT POWER SUPPLY SHALL BE ON A DEDICATED BRANCH CIRCUIT, THE CIRCUIT DISCONNECTING MEANS SHALL HAVE A RED MARKING, BE ACCESSIBLE ONLY TO AUTHORIZED PERSONNEL AND BE IDENTIFIED AS "FIRE ALARM CIRCUIT CONTROL," THE LOCATION OF THE CIRCUIT DISCONNECTING MEANS SHALL BE PERMANENTLY IDENTIFIED AT THE FIRE ALARM CONTROL UNIT.

LOCATION OF REMOTE POWER SUPPLIES MUST BE APPROVED BY ENGINEER. PROVIDE SMOKE DETECTOR IN ROOM FOR EACH UNIT.

FIRE ALARM STROBE SIGNALS SHALL CONTINUE TO FLASH, AFTER AUDIBLE SIGNALS ARE SILENCED, UNTIL SYSTEM IS RESET.

SEAL PENETRATIONS OF RATED WALLS TO MAINTAIN THE INTEGRITY OF THE WALL

PENETRATIONS OF EXTERIOR WALLS AND ROOF DECK SHALL BE WEATHER PROOFED.

ROUTING AND LOCATION OF EQUIPMENT AND CIRCUITS SHALL BE FIELD DETERMINED AND INDICATED ON AS-BUILT DRAWINGS. FINAL INSTALLATION SHALL BE IN STRICT COMPLIANCE WITH NFPA 72 AND ADAAG.

FIRE ALARM CONTRACTOR SHALL COORDINATE CONDUIT AND CONDUCTOR SIZES WITH SYSTEMS VENDOR AND SHALL PROVIDE MATERIAL AS REQUIRED.

HORN/STROBES AND STROBES SUPPLIES FOR THIS JOB SHALL BE WHITE IN COLOR.

FIRE ALARM WIRING SHALL BE RAN IN CONDUITS UNDER BOTTOM OF FLOOR JOIST OF ELEVATED WOODEN WALKWAYS.

PROVIDE AND INSTALL DITEK NO 2MHLPB-WS ON ALL INITIATING CIRCUITS ENTER/LEAVING THE BUILDING. PROVIDE AND INSTALL DEVICES IN JUNCTION BOX CONCEALED ABOVE ACCESSIBLE CEILING IMMEDIATELY AT BUILDING EXTERIOR WALL. PROPERLY GROUND DEVICE PER MANUFACTURER'S INSTRUCTIONS.

PROVIDE AND INSTALL DITEK NO. DTK-120SRD-A ON ALL 120V CIRCUITS PROVIDING POWER TO ANY AND ALL FIRE ALARM SYSTEM COMPONENTS. PROVIDE AND INSTALL EMPTY CABINET ADJACENT TO RESPECTIVE FIRE ALARM SYSTEM (MATCH FIRE ALARM SYSTEM

SECURITY CAMERA KEY NOTES:

(1) VICON VALERUS DVR WITH 16 COMPATIBLE VICON CAMERAS POSITIONED BY SECURITY CONTRACTOR FOR MAXIMUM COVERAGE. SECURITY CONTRACTOR SHALL BE RESPONSIBLE FOR MOUNTING, WIRING, CONNECTIONS AND INSTALLATION, AS WELL AS COORDINATION WITH OWNER'S DATA NETWORK.

FIRE ALARM KEY NOTES:

- (1) AUDIO/VISUAL DEVICES INSTALLED UNDER COVER WALKWAY SHALL BE LISTED FOR
- 2 APPROXIMATE LOCATION OF NEW SIEMENS CERBERUS PACE VOICE EVAC FIRE ALARM

	INTERCOM LEGEND
SYMBOL	DESCRIPTION
•	INTERCOM SPEAKER
₽	EXTERIOR INTERCOM SPEAKER
С	CALL BUTTON
IS	MASTER INTERCOM STATION
	EXTERIOR INTERCOM CLOCK
GB-69	INTERCOM CLOCK
	SECURITY CAMERA

ALL INTERCOM EQUIPMENT, HEAD IN EQUIPMENT, ALL DEVICES & ACCESSORIES SHALL BE TELCORE E-SERIES.

	FIRE ALARM LEGEND NOT ALL DEVICES ARE NECESSARILY USED ON THIS PROJECT	
SYMBOL	DESCRIPTION	
Ф	SMOKE DETECTOR (CEILING MOUNTED)	
HWP	WEATHER PROOF HEAT DETECTOR (CEILING MOUNTED)	
F	WEATHER PROOF FIRE ALARM PULL STATION WITH STI STOPPER II COVER	
	FIRE ALARM SPEAKER/STROBE UNIT (CEILING MOUNTED)	
�	FIRE ALARM STROBE UNIT (CEILING MOUNTED)	
FACP	FIRE ALARM VOICE EVAC PANEL - SIEMENS CERBERUS PACE	
WP	DENOTES WEATHERPROOF DEVICE	

NOTE: FIRE ALARM DEVICES SHOWN ARE PRESCRIPTIVE. FINAL DESIGN TO

BE COMPLETED BY FIRE ALARM CONTRACTOR AND APPROVED BY FIRE MARSHALL PRIOR TO INSTALLATION.

FA2.0 PRINT DATE 09/19/2020

PROJECT NUMBER

PROFESSIONAL

CHAMPEAUX EVANS HOTARD, APAC

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St. Louis Catholic

High School


Modular Campus

1620 Bank St

Lake Charles, LA 70601

Fire Alarm/Intercom/Security Camera Site Plan

SCALE: 1'' = 20'-0''

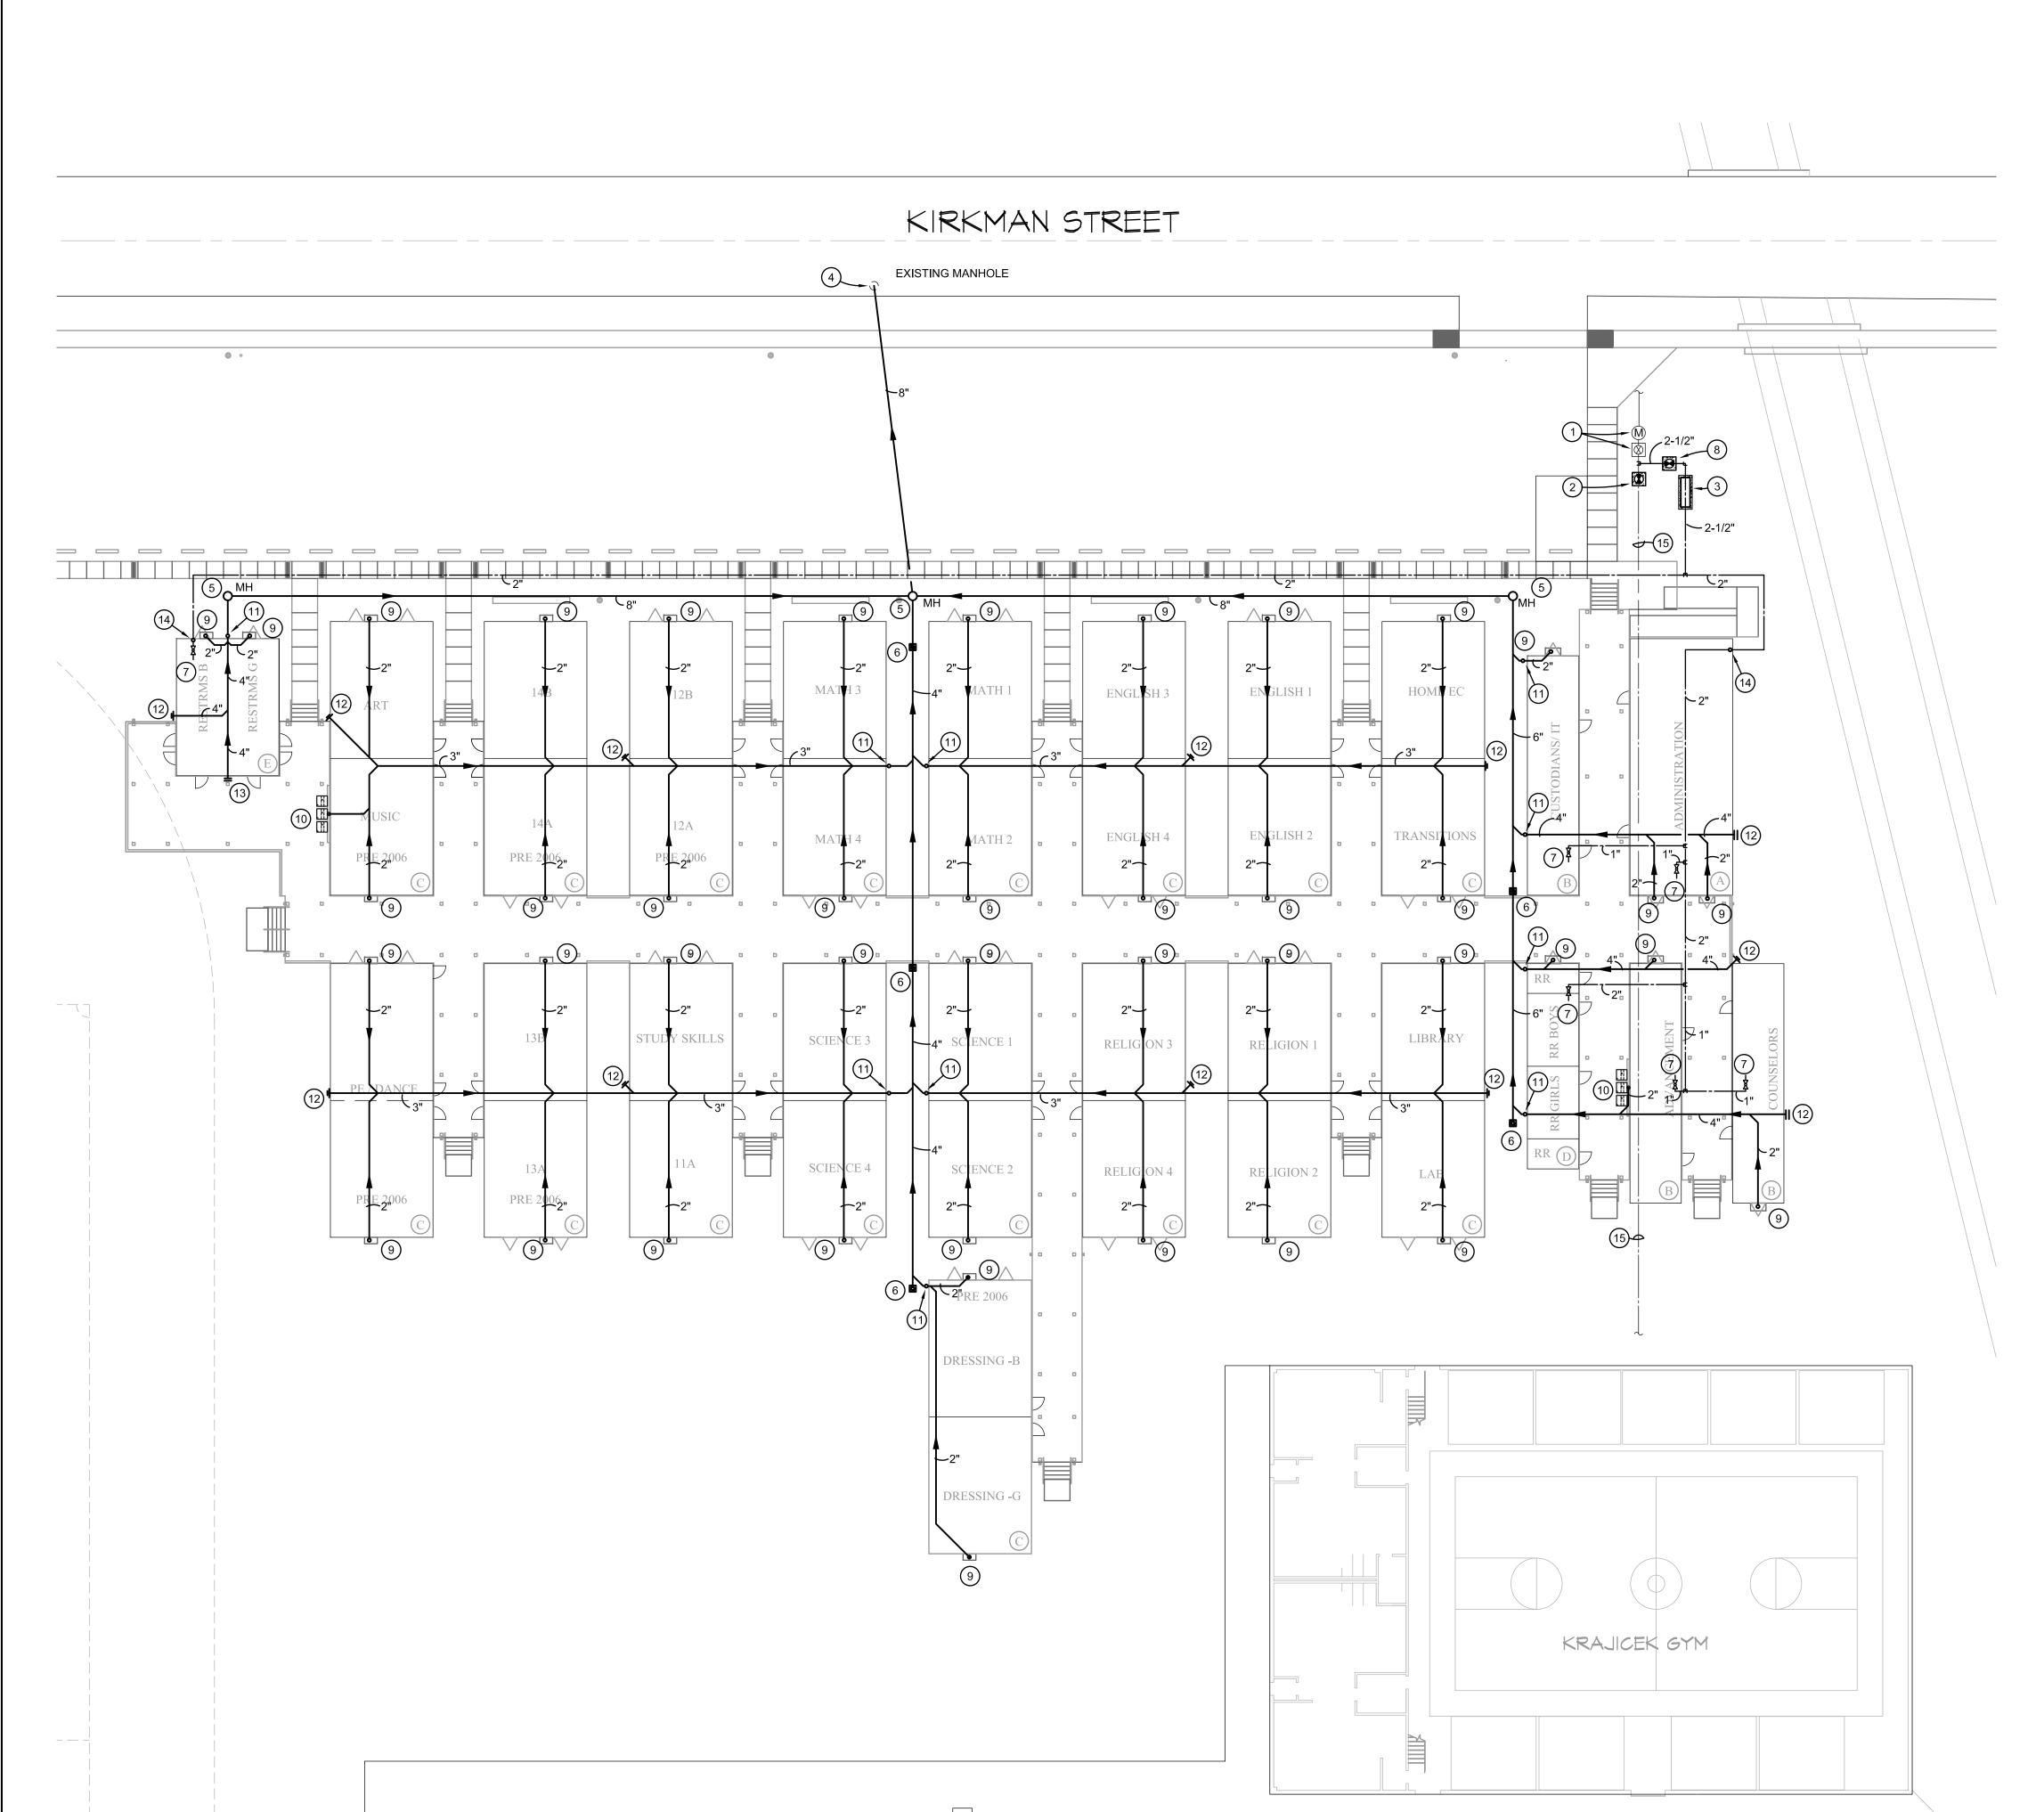

PLUMBING GENERAL NOTES:


- A. ALL WORK SHALL BE IN ACCORDANCE WITH APPLICABLE LOCAL, STATE, AND FEDERAL CODES (INCLUDING INTERNATIONAL PLUMBING CODE, INTERNATIONAL BUILDING CODE, INTERNATIONAL FUEL GAS CODE, NFPA, ETC.) AND APPLICABLE DEQ AND DHHOP REGULATIONS TO THE SATISFACTION OF THE AUTHORITIES HAVING JURISDICTION. CONTRACTOR SHALL OBTAIN REQUIRED PERMITS AND APPROPRIATE WORK AUTHORIZATION PRIOR TO BEGINNING WORK.
- B. CONTRACTOR SHALL VERIFY EXACT LOCATION OF UTILITIES, INVERT ELEVATIONS, ETC. PRIOR TO BEGINNING ANY ROUGH-IN OF SUBSURFACE WORK. COORDINATE ALL UTILITY TIE-IN REQUIREMENTS WITH RESPECTIVE UTILITIES.
- C. REFER TO ARCHITECTURAL DRAWINGS FOR ALL DIMENSIONS, DETAILS, ETC. INSTALL WORK TO CONFORM TO ARCHITECTURAL AND STRUCTURAL DRAWINGS AS REQUIRED. REVIEW COMPLETE SET OF CONTRACT DOCUMENTS PRIOR TO SUBMITTING BID.
- D. CONTRACTOR SHALL RUN ALL NEW UTILITIES (WATER, SEWER, ETC.) AROUND NEW CONSTRUCTION AREA AS INDICATED PRIOR TO SHUTTING DOWN OR TIE-ING INTO ANY SYSTEMS. COORDINATE ALL UTILITY SERVICE DISRUPTIONS TO OTHER UTILITY CUSTOMERS WITH RESPECTIVE UTILITY. ALL UTILITY RELOCATION (SUCH AS WATER) SHALL BE DONE IN STRICT COMPLIANCE WITH UTILITY COMPANY STANDARDS AND REQUIREMENTS. CONTACT UTILITY COMPANY, VERIFY AND DOCUMENT REQUIREMENTS, COSTS, CHARGES, ETC. CONTRACTOR SHALL FULLY COMPLY WITH ALL UTILITY COMPANY REQUIREMENTS.
- E. COORDINATE ALL WORK THROUGH GENERAL CONTRACTOR. COORDINATE CUTTING, PATCHING, TRENCHING WORK WITH SITE GRADING / PAVING PLAN.
- F. UNDERGROUND UTILITIES ARE APPROXIMATE. VERIFY INVERTS AND EXACT LOCATIONS WITH UTILITY PERSONNEL. VERIFY ALL EASEMENTS WITH APPROPRIATE PARTIES. ADJUST ALL UTILITY LINES ACCORDINGLY.
- G. COORDINATE INSTALLATION OF ALL PLUMBING, PIPING, ETC. WITH ARCHITECTURAL, STRUCTURAL, CIVIL,
- MECHANICAL, ELECTRICAL, EXISTING AND NEW CONDITIONS, ALL TRADES, ETC.
- H. ALL DOMESTIC WATER BRANCH LINES SHALL HAVE VALVES AT MAINLINES.

PLUMBING KEYNOTES:

- 1) EXISTING 2" METER AND WATER MAIN SHUTOFF VALVE TO REMAIN.
- PROVIDE DOMESTIC WATER SHUTOFF VALVE IN CAST IRON VALVE BOX WITH CONCRETE PAD AND METAL COVER MARKED "WATER" ON EXISTING WATER LINE SERVING GYM. REFER TO DETAIL 2 / P2.0.
- PROVIDE AND INSTALL A 2-1/2" WATTS SERIES LF009 REDUCE PRESSURE ZONE BACKFLOW PREVENTER AS PER LOCAL CODES. BACKFLOW PREVENTER SHALL HAVE BRONZE STRAINER, STAINLESS STEEL CHECK SEATS, BALL TYPE CUTOFF VALVES, SPRING LOADED "Y" PATTERN CHECK VALVES, RELIEF VALVE, TEST COCKS, AND SHALL CONFORM TO ALL CODES. INSULATE AS PER SPECIFICATIONS. PROVIDE A INSULATED HEATED ENCLOSURE HOT BOX MODEL HB3NS WITH A 1500 WATT HEATER (120-1-60) OVER BACKFLOW PREVENTER. COORDINATE COLOR AND LOCATION OF HOT BOX WITH ARCHITECT. PROVIDE CONCRETE PAD FOR ANCHOR INSTALLATION.
- 4 CONNECT TO EXISTING SANITARY SEWER MANHOLE IN THIS VICINITY IN ACCORDANCE WITH STATE AND LOCAL UTILITIES DEPARTMENT REQUIREMENTS. VERIFY FLOW DIRECTION, INVERT, LINE SIZE, AND TIE-IN LOCATION PRIOR TO ANY ROUGH-INS. PLUMBING CONTRACTOR SHALL PAY ALL SERVICE AND CONNECTION CHARGES. CONTRACTOR SHALL CUT AND PATCH STREET PER CITY STANDARDS AS REQUIRED FOR NEW TAP.
- 5) PROVIDE NEW FIBERGLASS MANHOLE COMPLYING WITH CITY OF LAKE CHARLES STANDARD SPECIFICATIONS FOR INFRASTRUCTURE CONSTRUCTION. VERIFY EXACT INVERT AND ELEVATION IN FIELD.
- (6) PROVIDE EXTERIOR CLEANOUT WITH CONCRETE PAD PER DETAIL 2 / P2.0.
- 7 CONNECT SEWER AND WATER TO ALL PLUMBING FIXTURES AND WATER HEATERS IN TEMPORARY BUILDINGS. REFER TO MANUFACTURERS DETAILS FOR CONNECTION LOCATIONS AND SIZES.
- 8 PROVIDE DOMESTIC WATER SHUTOFF VALVE IN CAST IRON VALVE BOX WITH CONCRETE PAD AND METAL COVER MARKED "WATER". REFER TO DETAIL 2 / P2.0.
- 9 PROVIDE A 2" HUB DRAIN FOR INDIRECT CONDENSATE DRAIN AT EACH A/C UNIT. EXTEND A/C UNIT DRAIN LINE TO HUB DRAIN. CONNECT HUB DRAINS TO NEW SEWER LINES AS SHOWN. CONDENSATE DRAIN LINES MAY RUN ABOVE GRADE WHERE CONCEALED BY BUILDINGS AND WALKWAYS.
- PROVIDE THREE OUTDOOR VANDAL RESISTANT ELECTRIC WATER COOLERS WITH BOTTLE FILLERS (120-1-60 ELECT. SERVICE) AT EACH RESTROOM LOCATION. MOUNT TO TEMPORARY WALL SHOWN ON ARCHITECTURAL PLANS UNDER CANOPY. EWC SHALL BE ELKAY VRC8WSK. MOUNT ONE AT EACH LOCATION AT ADA HEIGHT AND THE OTHER TWO AT STANDARD HEIGHT. COORDINATE EXACT LOCATION IN FIELD WITH ARCHITECT AND ELECTRICAL CONTRACTOR PRIOR TO ROUGH-IN.
- (11) DROP DOWN WITH SEWER LINE FROM ABOVE GRADE TO BELOW GRADE IN THIS VICINITY.
- PROVIDE END CLEANOUT CAP AT EDGE OF TEMPORARY BUILDING. TURN UP AND RISE TO FLUSH WITH FINISHED FLOOR ELEVATION.
- (13) PROVIDE WALL CLEANOUT CAP ON WASTE STACK ABOVE FLOOR.
- RISE UP WITH WATER LINE TO ABOVE GRADE BELOW TEMPORARY BUILDING. ALL WATER LINES ABOVE GRADE SHALL BE INSULATED AND COVERED WITH ALUMINUM JACKETS. PROVIDE HANGERS AND CONNECT TO ALL PLUMBING FIXTURE WATER CONNECTION POINTS.
- ASSUMED LOCATION OF EXISTING WATER LINE SERVING GYM. VERIFY EXACT LOCATION IN FIELD PRIOR TO TRENCHING.

NOTE:

MANHOLES, COVERS, SEWER MAIN, WATER MAINS AND INSTALLATION, EXCAVATION, BEDDING, TESTING, ETC. SHALL COMPLY WITH CITY OF LAKE CHARLES STANDARD SPECIFICATIONS FOR INFRASTRUCTURE CONSTRUCTION. CONTRACTOR SHALL OBTAIN INSPECTION FROM CITY OF LAKE CHARLES PRIOR TO COVERING MANHOLES, SITE SEWER PIPING AND SITE WATER PIPING WITH DIRT.

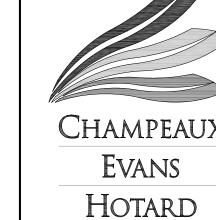

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St. Louis Catholic High School Modular Campus

1620 Bank St Lake Charles, LA 70601

PROJECT NUMBER




CHAMPEAUX EVANS HOTARD, APAC


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P1.0

connection with the project.

PRINT DATE 09/19/2020



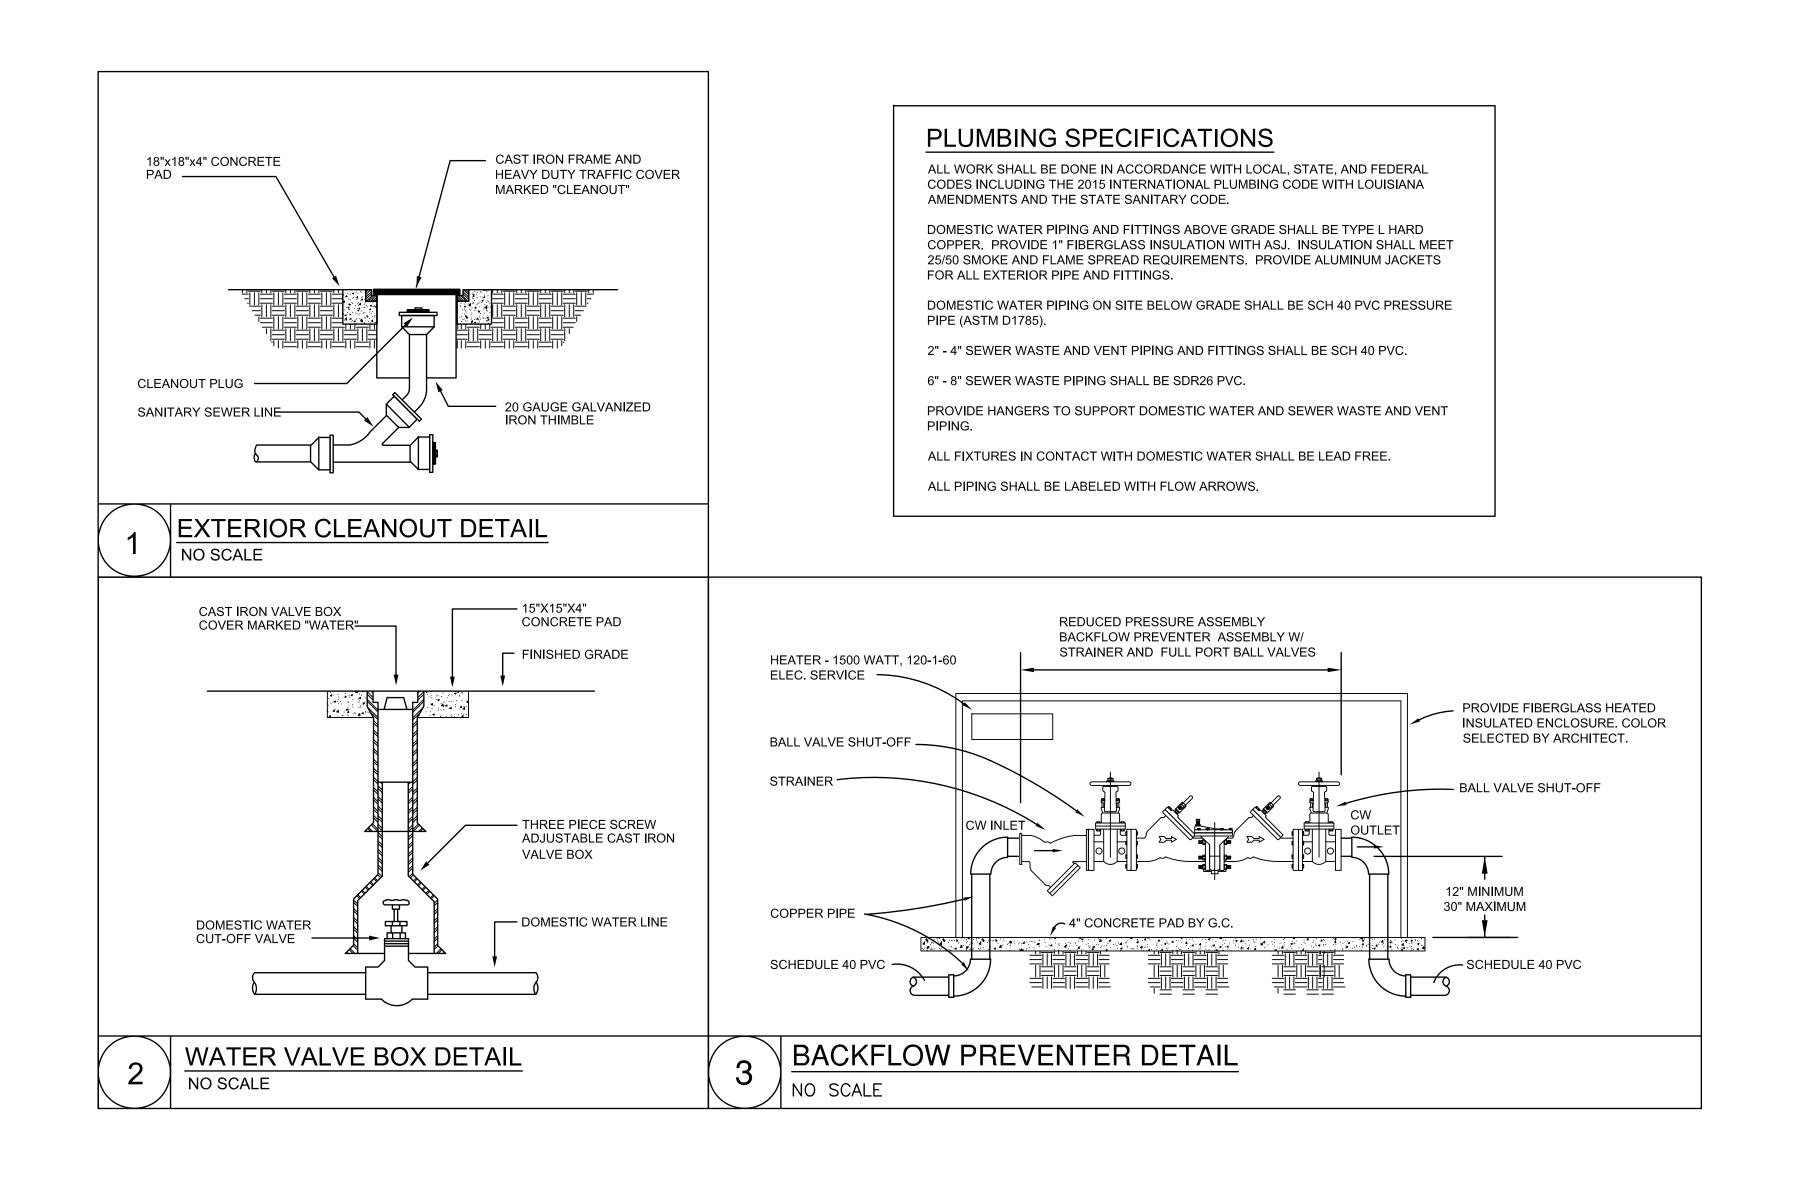
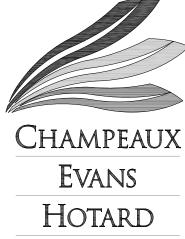
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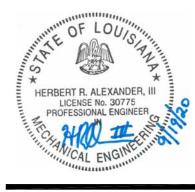
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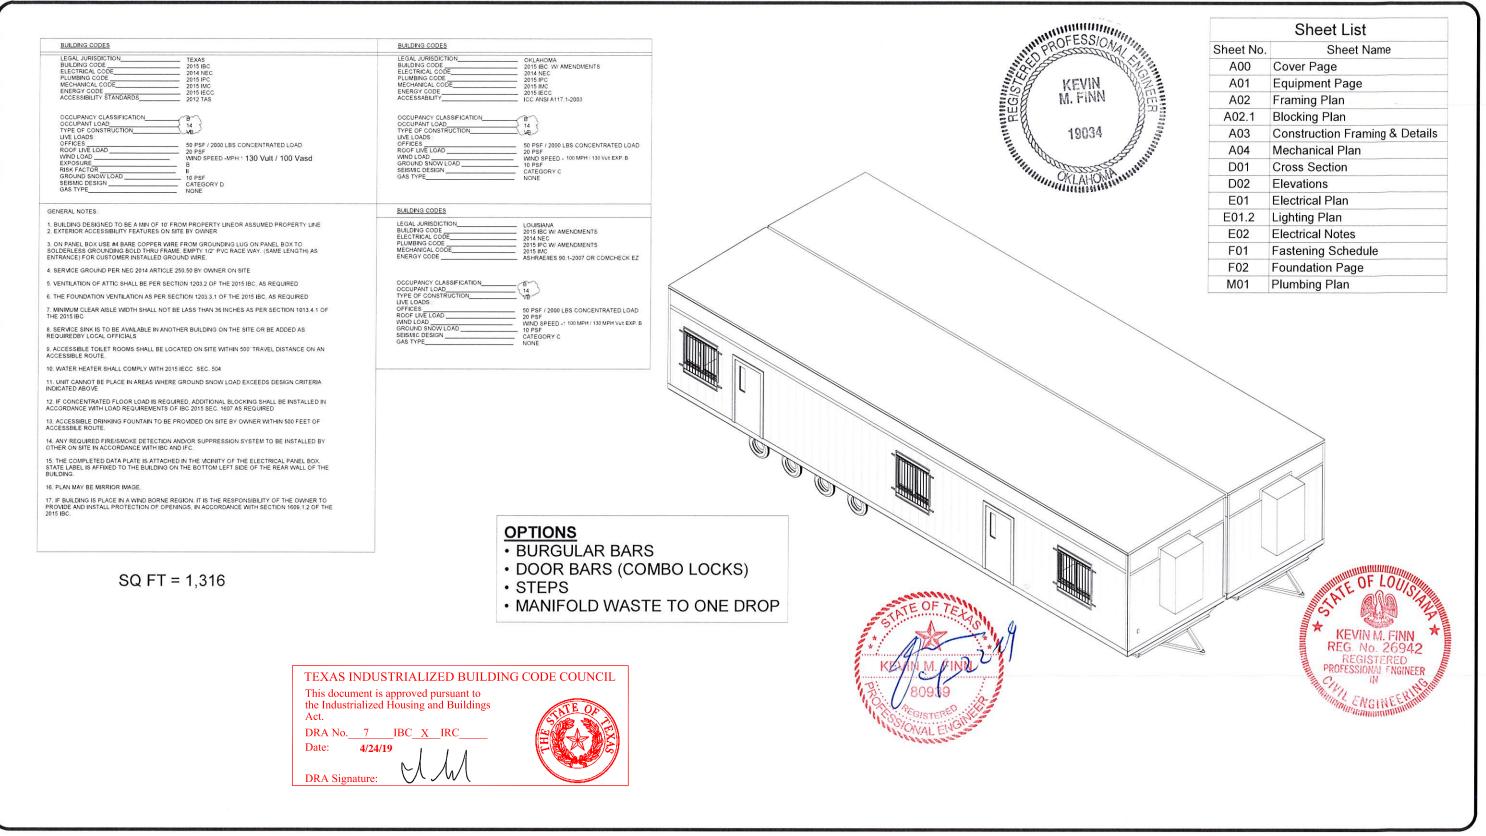
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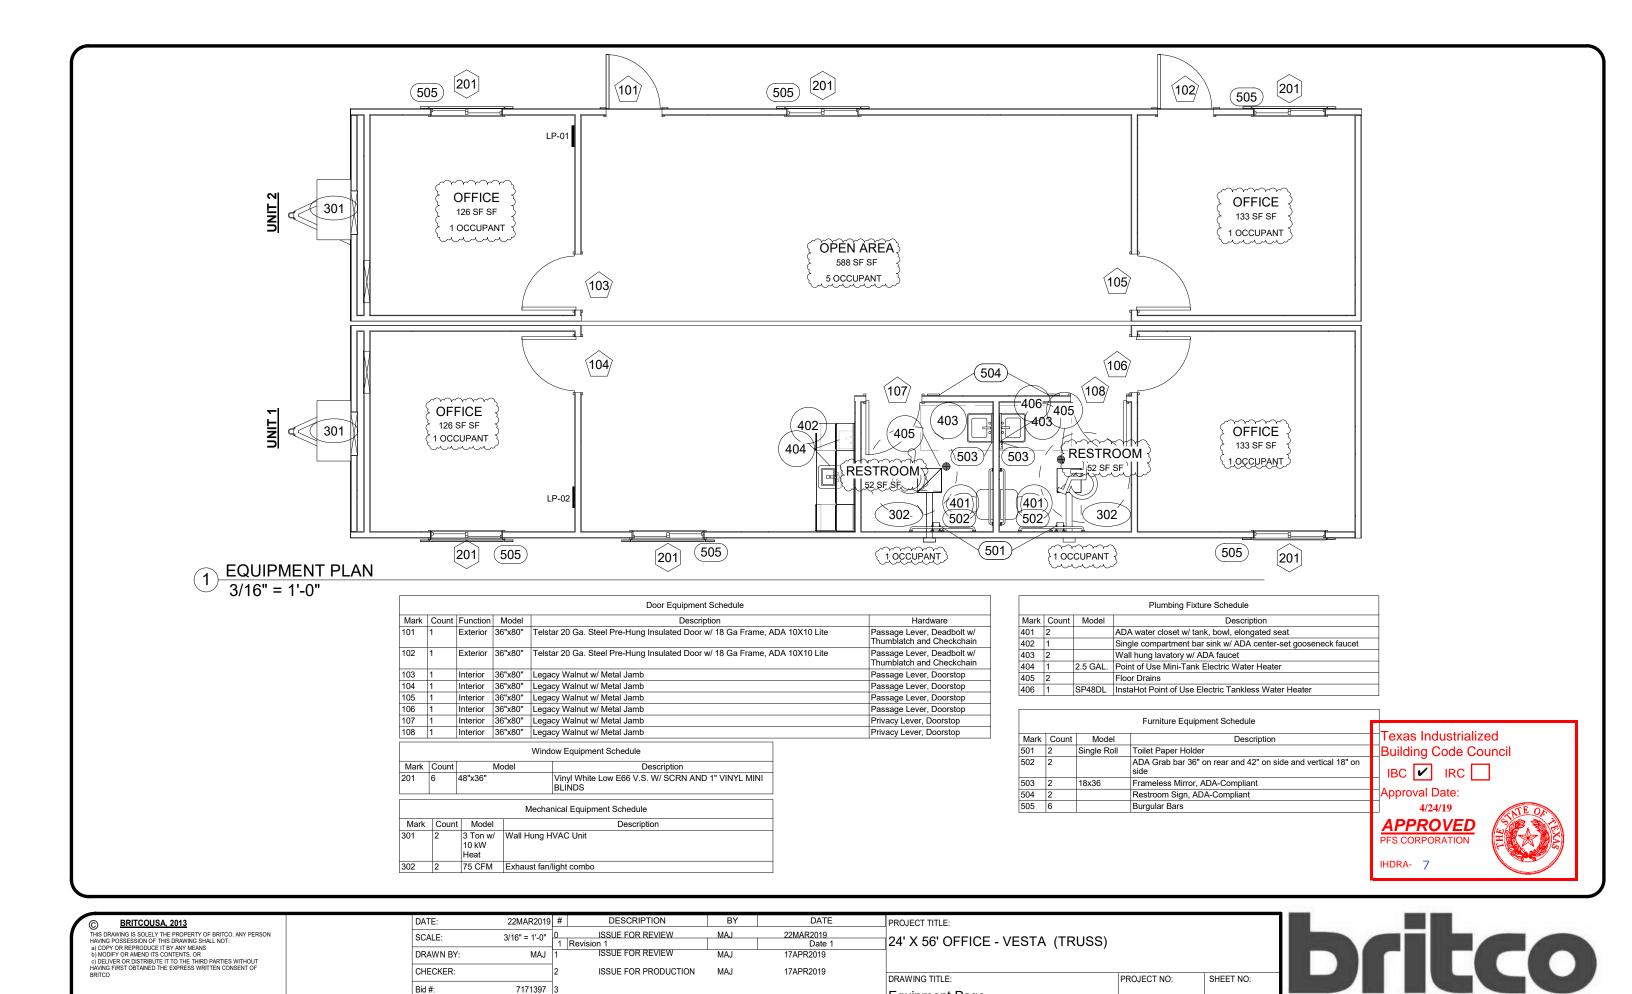
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Tel: (254) 741-6701	LA Firm # 5353								






1101 Foundation Dr., Waco, TX 76712 Tel: (254) 741-6701 Equipment Page

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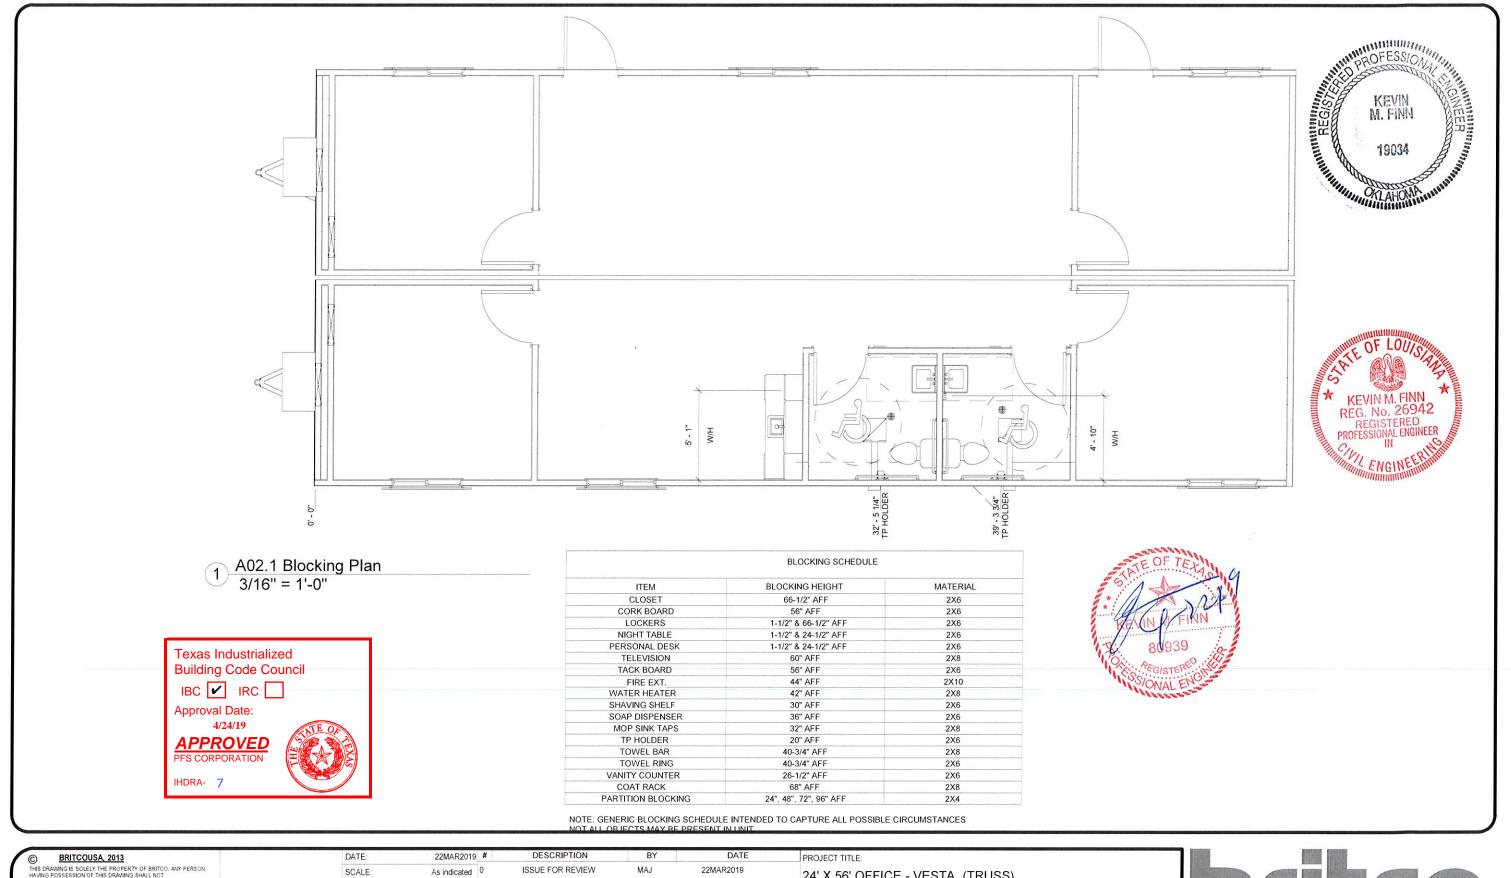
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BUILDING INNOVATION




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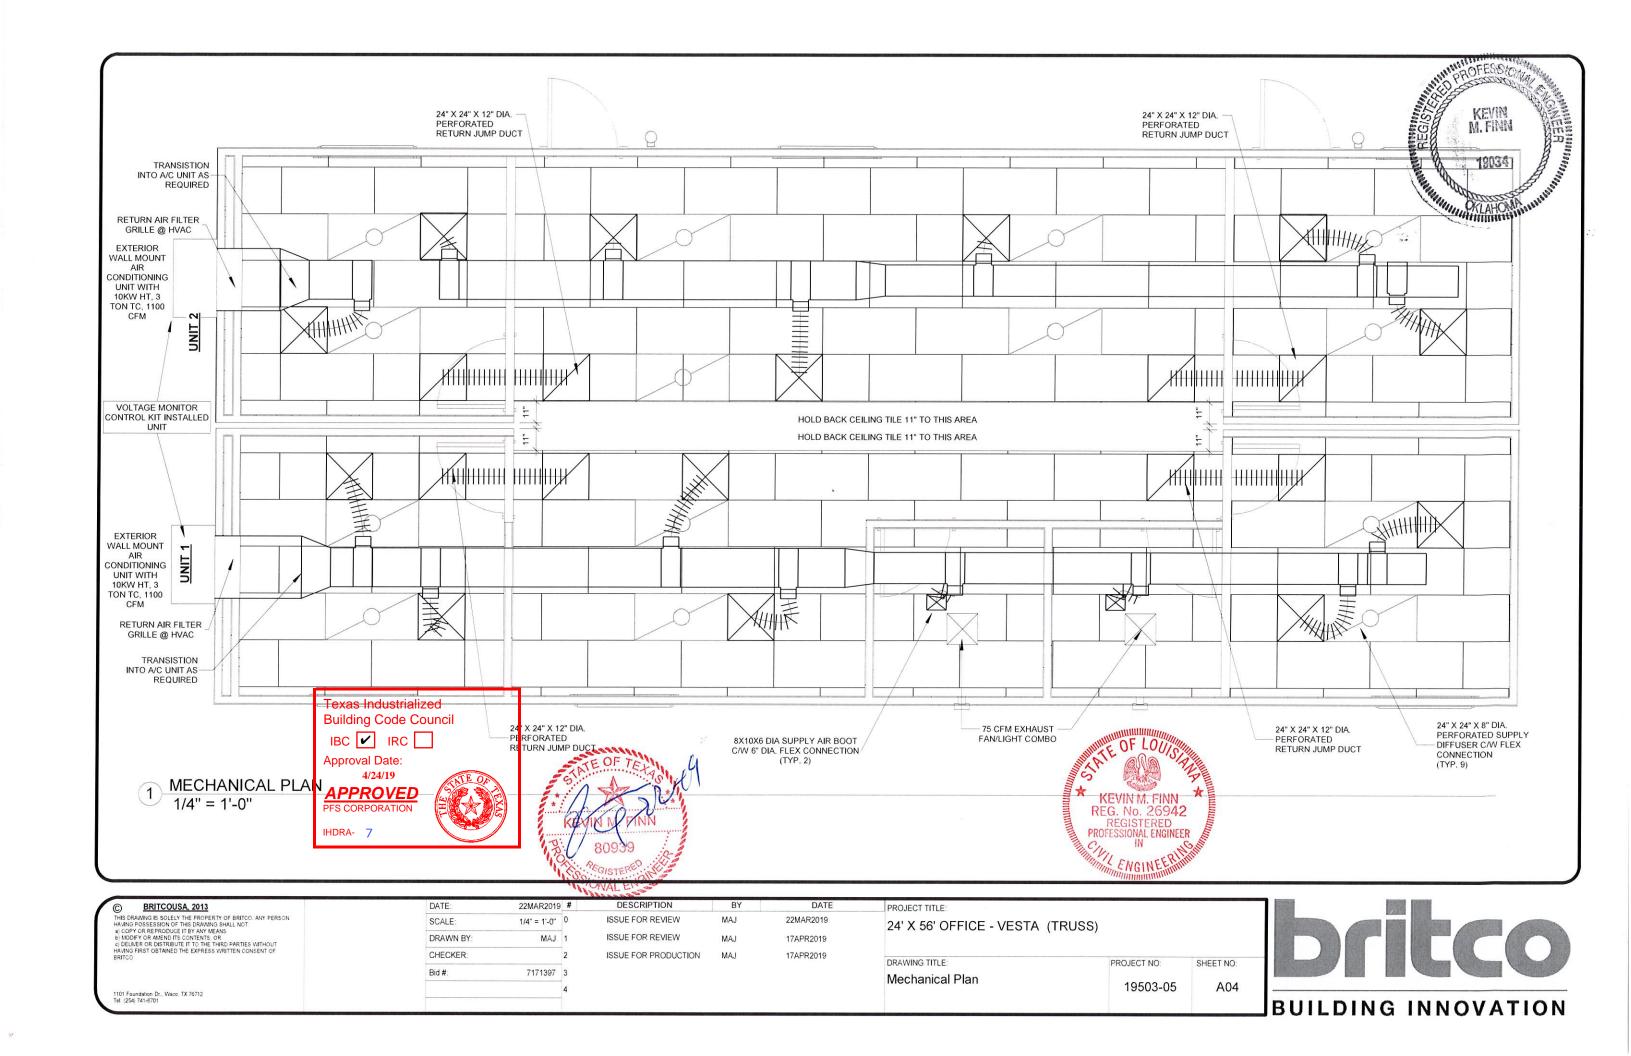
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1101 Foundation Dr., Waco, TX 76712 Tel (254) 741-6701		4				Construction Framing & Details	19503-05	A03

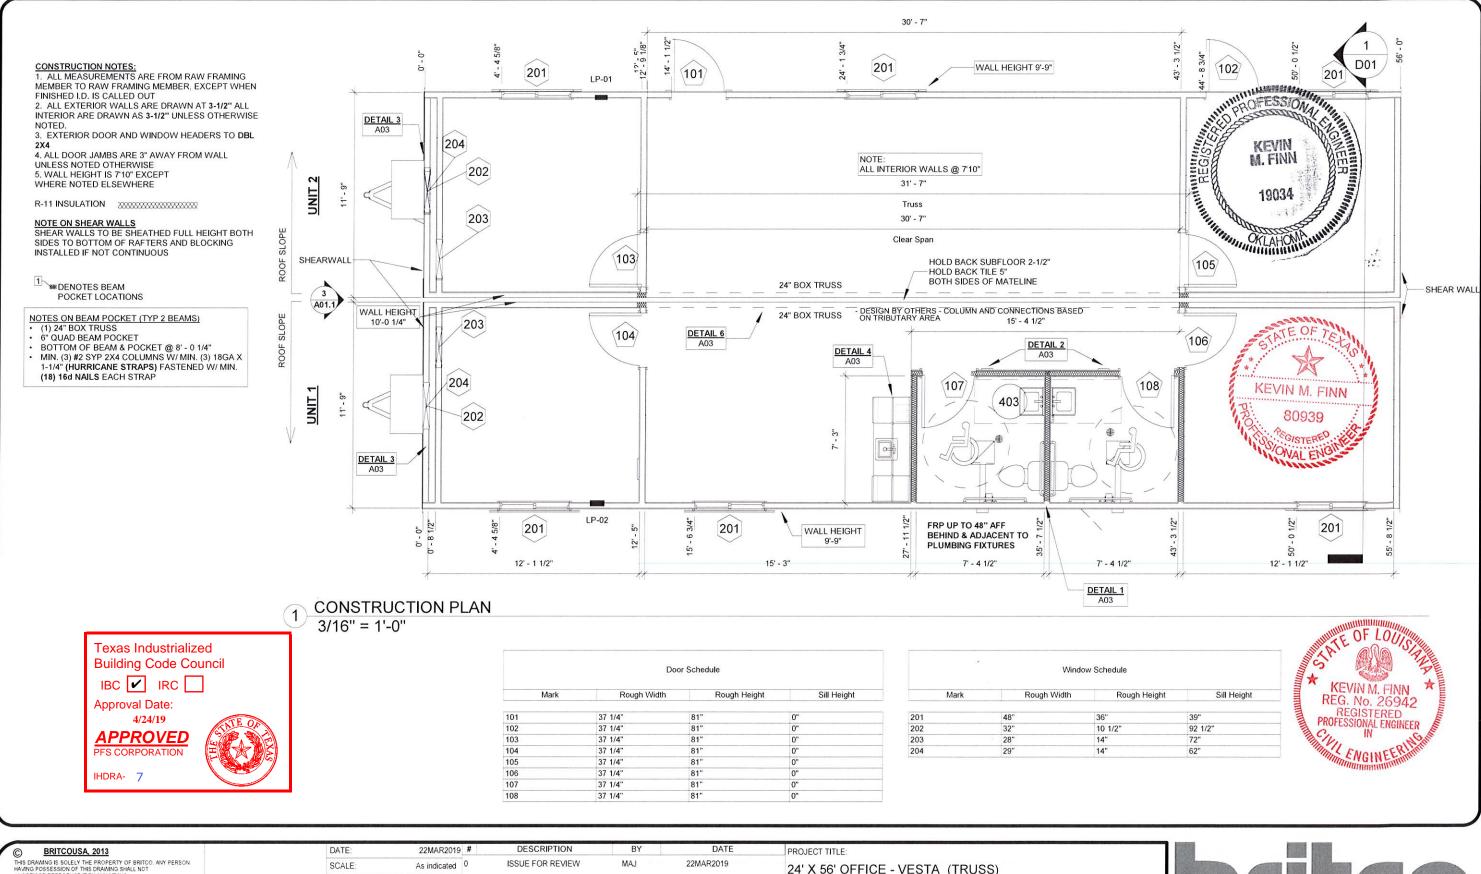






CROSS SECTION

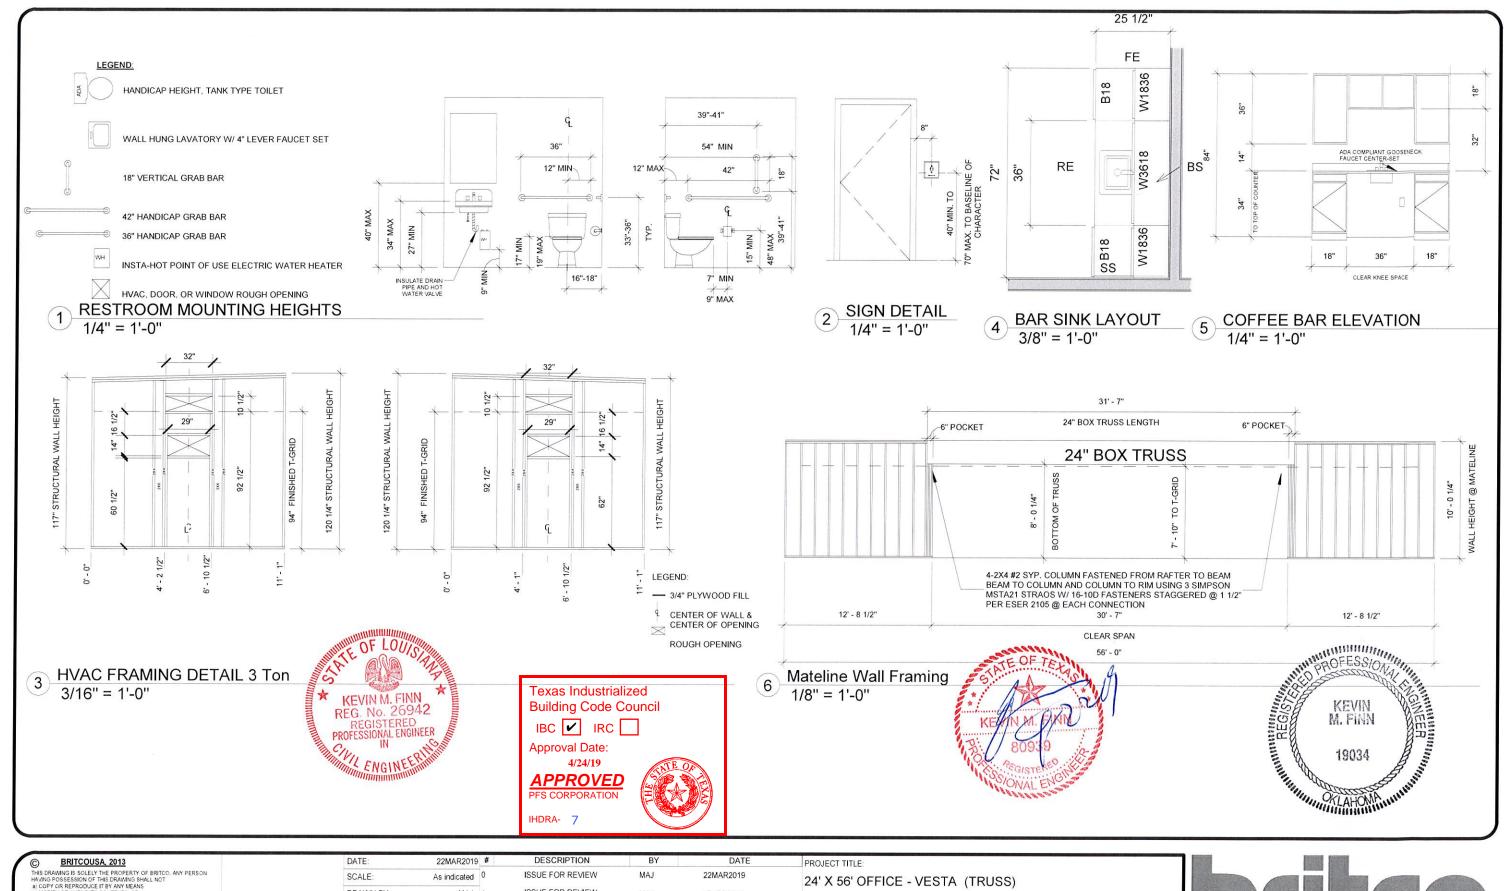3/8" = 1'-0"

RAFTER TO BEAM CONNECTION



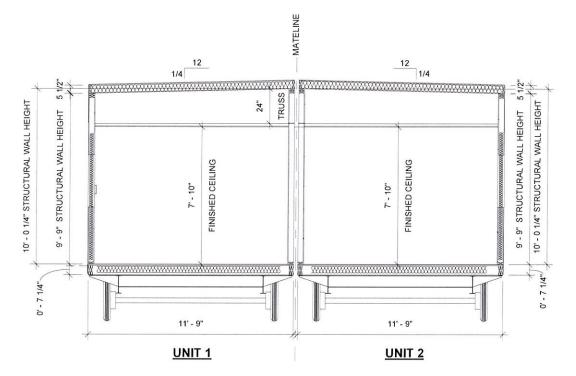



RAFTER TO WALL CONNECTION 3/8" = 1'-0"

FRAME

Frame: 12' X 60' (56' BOX SIZE) 12" - I-BEAM

Axle: 1BR -3DR AXLES Hitch: REMOVABLE HITCH

Tires: 14 PLY TIRES

FLOORS

Undersheathing: .040 MOBILE FLEX WOVEN PLASTIC TYPE OR EQUAL

2x8 #2 SYP @ 16" O.C.DOUBLE RIM JOIST Floor Joist: Insulation: R-30 UNFACED FIBERGLASS INSULATION Subfloor: 3/4" T&G PLYWOOD - SINGLE LAYER Floor Covering: COMMERCIAL GRADE 12"X12"X1/8" VCT TILE

THROUGHOUT (STAGGERED)

EXTERIOR WALLS

Wall Framing: 2x4 #2 SYP @ 16" O.C.

Top Plate: DOUBLE Bottom Plate: SINGLE

Insulation: R-13 UN-FACED FIBERGLASS INSULATION-FRICTION FIT

Interior Covering: 1/2" VCG WITH MATCHING BATTENS

Base: 4" VINYL COVE BASE THROUGHOUT Building Wrap: HOUSEWRAP UNDER EXT. SIDING

Ext. Siding: 3/8" L.P. SMART PANEL SIDING 8" VERTICAL

Ext. Trim: 3/4" X 4" SMART PANEL TRIM

DOORS, WINDOWS, CORNERS, HVAC

3/4" X 6" SMART PANEL TRIM

BOTTOM

FRP: 48" AFF IN RESTROOMS, BEHIND & ADJACENT TO

PLUMBING FIXTURES

INTERIOR WALLS

Wall Framing: 2x4 #2 SYP @ 16 O.C., 2X6 PLUMBING WALL @ 16" O.C.

Insulation: R-11 UNFACED FIBERGLASS FOR SOUND ATTENUATION Top Plate: SINGLE

Bottom Plate: SINGLE

Interior Covering: 1/2" VCG MATCHING BATTENS

Base: 4" VINYL COVE BASE THROUGHOUT

48" AFF IN RESTROOMS, BEHIND & ADJACENT TO

PLUMBING FIXTURES

Mateline: MATELINE JUNCTION 24' 4 LAYER PLYWOOD BEAM OF 3/4"

CDX GLUES AND FASTENED

ROOF

Roof Framing: 2x6 #2 SYP @ 16" O.C, SINGLE RIM HEADERS

Insulation: R-38 UNFACED FIBERGLASS INSULATION-FRICTION FIT

W/ BACK SUPPORT NETTING

Roof Sheathing: 7/16" MULEHIDE FR DECKING PER ESR 1776

045 WHITE EPDM SINGLE PLY EPDM FULLY ADHESIVE

AND INSTALLED PER ESR 1463 WITH ALUMINUM DRIP

RAIL TO PERIMETER SR:064 3YR / TE:0.87 3YR

2x4 T-GRID SUSPENDED CEILING (GRIDSTONE TO R.R.)

(STAGGERED)


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PROJECT TITLE: 24' X 56' OFFICE - VESTA (TRUSS)

DRAWING TITLE: PROJECT NO: SHEET NO: Cross Section 19503-05 D01




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	Bid #:	7171397 3				Elevations	TROJECT NO.	
101 Foundation Dr., Waco, TX 76712		4				Lievations	19503-05	D02

BUILDING INNOVATION

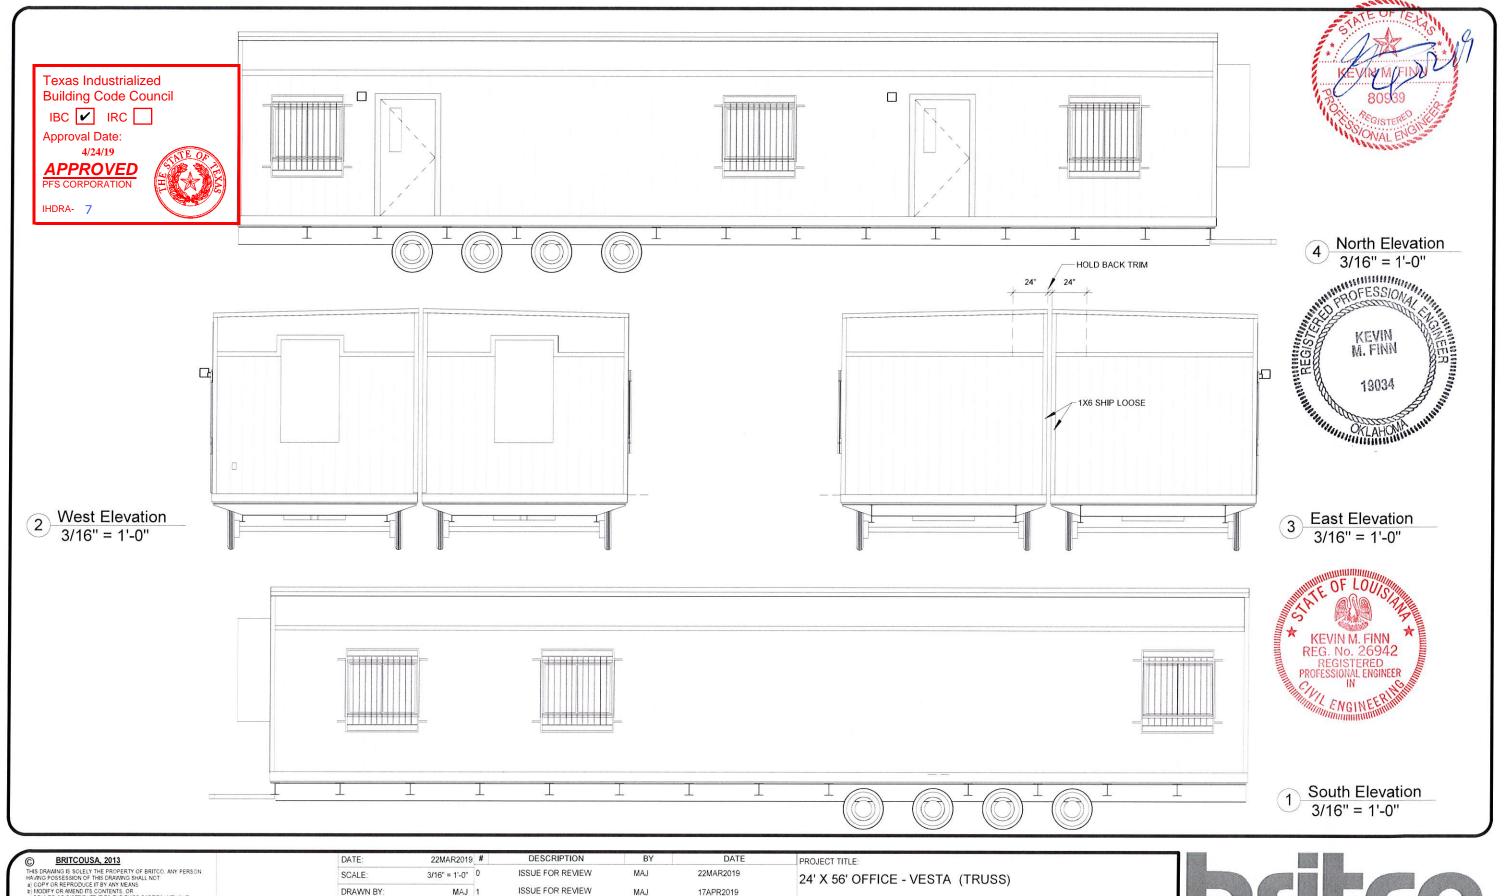

NOTE: GENERIC ELECTRICAL LEGEND INTENDED TO CAPTURE ALL POSSIBLE CIRCUMSTANCES. NOT ALL OBJECTS MAY BE PRESENT IN UNIT

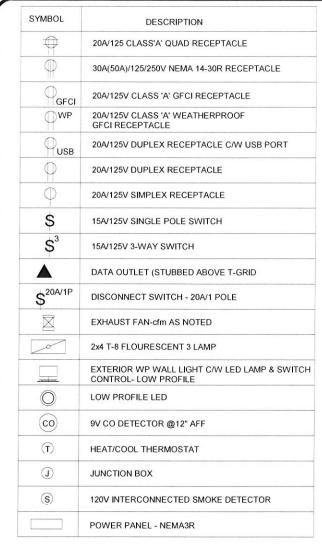LP-01 6 8 8 8 9 DATA OUTLET 6 LP-01 RECESSED 8 🕀 INTERIOR PANEL DATA OUTLET 6' - 0" EXTERIOR WALL MOUNT AIR CONDITIONING UNIT WITH 10KW HT, 3 TON TC, 1100 CFM ≗ 13 DATA OUTLET 1,3 8 etci RECESSED DATA OUTLET INTERIOR PANEL 11 6 12 - <u>CKT 14</u> SP48 INSTAHOT POINT OF USE WATER HEATER CKT 9 2.5 GAL. EEMAX PROGRAMMABLE THERMOSTAT WATER HEATER

NOTE: DIMENSIONS ARE APPROXIMATE; ALWAYS LOCATE RECEPTS & SWITCHES TO NEAREST STUD

STANDARD OUTLET MOUNTING HEIGHTS HEIGHT IN INCHES TO BOTTOM OF BOX UNLESS OTHERWISE NOTED

ELECTRICAL BOX TYPE MTG HT (AFF) ELECTRICAL BOX TYPE MTG HT (AFF) WALL RECEPTACLE 16 PHONE LIGHT SWITCH 44 TELE/DATA OUTLET MICROWAVE RECEPT WATER HEATER TV RECEPT. 60 **EXTERIOR LIGHT** 78 ANTENNA BOX EXTERIOR RECEPT. 16 COMMON KITCHEN RECEPT. 42 WASHER 36 LOWER BUNK LIGHT TWIN/FULL 40 DRYER 36 UPPER BUNK LIGHT TWIN/FULL 83 THERMOSTAT - CENTERLINE 60 **BUNK LIGHT DIMMER** 38 OFFICE UPPER RECEPT. 39 STOVE 16 OFFICE LOWER RECEPT 16 BEDROOM VALENCE LIGHT VANITY GFI DISHWASHER 16 OFFICE DUPLEX 39



ELECTRICAL PLAN

PROGRAMMABLE THERMOSTAT





DATA OUTLET

DATA OUTLET

6' - 10 5/8"


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		4				Licetrical Flair	19503-05	E01





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Foundation Dr. Waco TX 76712		4				Lighting Plan	19503-05	E01

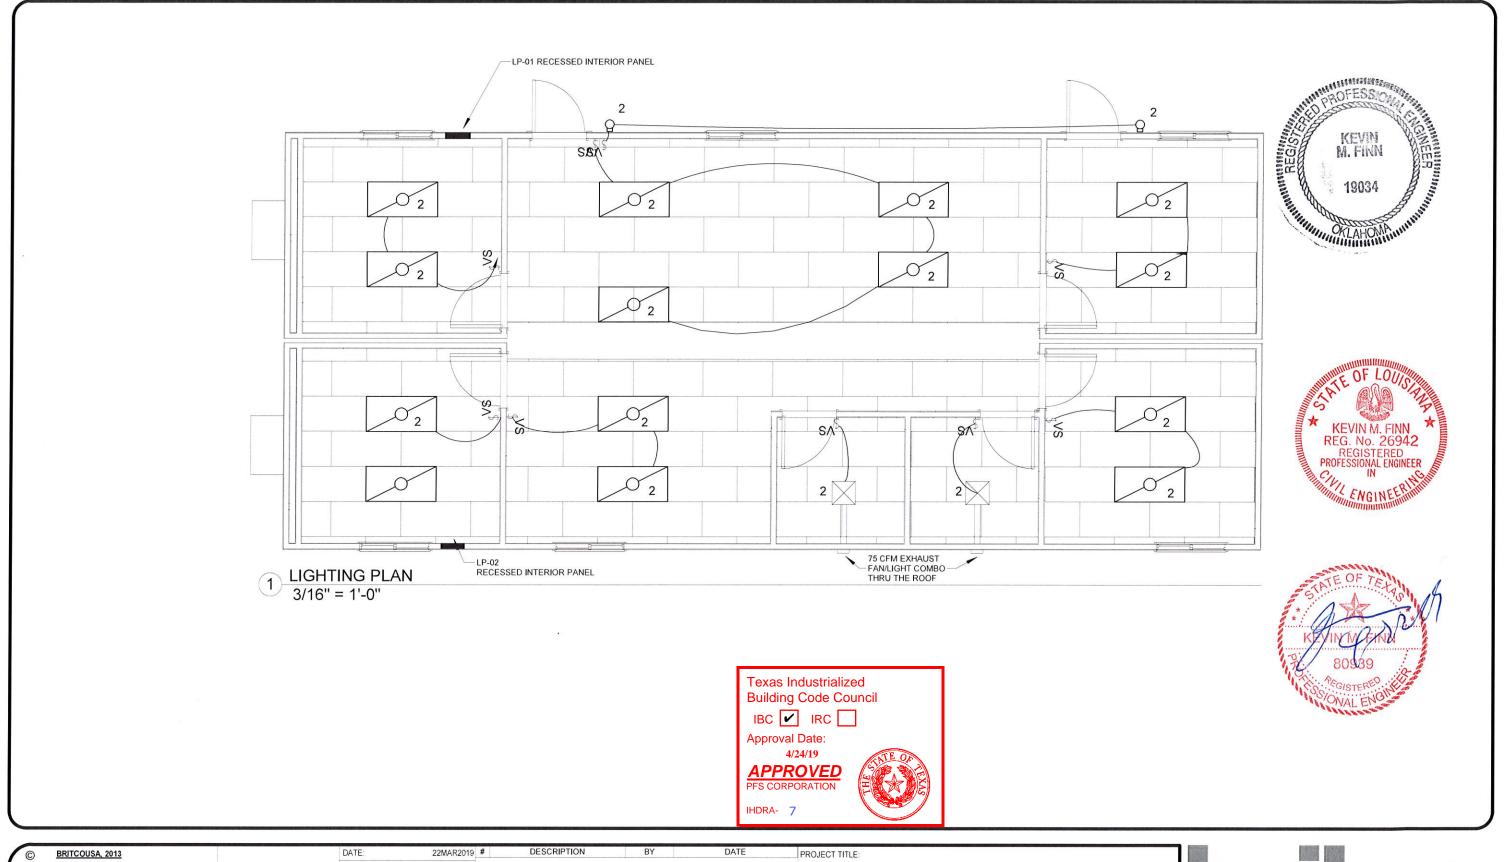

		LIGHTING FIXTURES SCHED	ULE
Count	~~~~	Description Description	Project Notes
14	2x4 SUPER 32W BULBS	T-8 (3-LAMP) FLUORESCENT TROFFER W/ - ELECTRONIC BALLAST	
2	60W MOTIO	N SENSING PORCH LIGHT w/ PHOTOCELL	
~~~		LIGHTING SWITCHES SCHED	OULE
Count		Description	Project Notes
9	15A/125V SII	NGLE POLE SWITCH W/ VACANCY SENSOF	₹
	EL	ECTRICAL EQUIPMENT SCH	EDULE
Count		Description	Project Notes
2	INTERIOR R	ECESSED POWER PANEL - 100A	
Count	20A/125V CI	Project Notes	
2	20A/125V CL	ASS "A" WEATHERPROOF GFCI RECEPTAGE	CLE
23		IPLEX RECEPTACLE	
3		CI RECEPTACLE	
1		THERMOSTAT	
10	TELE/DATA		
11	THERMOSTA	AT - DIGITAL 7-DAY PROGRAMMABLE	
		MECHANICAL EQUIPMENT	Г
	Count	Description	Project Notes
2		Bard Wall Hung Unit: 3 Ton	
2		Fan light combo: 2'x4'(2 Lamp) - 120V	

#### **ELECTRICAL NOTES:**

- 1. WIRING METHOD TO BE MC CABLE, COPPER, HOME RUN TO BE EMT CONDUIT W/ COPPER WIRE, MINIMUM #12AWG
- 2. BLANK SPACES IN PANEL MAY BE OMITTED TO MAKE US OF SMALLER PANELS. BREAKER SIZE AND QUANTITY SHALL REMAIN THE SAME.
- 3. ALL ELECTRICAL CONNECTIONS TO BE MOUNTED 14" AFF UNLESS OTHERWISE SPECIFIED. ALL HEIGHTS ARE MEASURED TO THE BOTTOM OF BOX.
- 4. TELE/DATA OUTLETS ARE TO HAVE A 3/4" FLEXIBLE CONDUIT STUBBED UP INTO THE CEILING SPACE UNLESS NOTED.
- ALL CONDUIT TO CONTAIN AN INSULATED GROUND CONDUCTOR SIZED AS REQUIRED BY 2015 N.E.C., MINIMUM #14 AWG.
- 6. ELECTRICAL INSTALLATION SHALL BE IN COMPLIANCE WITH 2015 N.E.C.
- 7. ALL WIRING IN RETURN AIR PLENUMS SHALL MEET RATING REQUIREMENTS OF 2015 N.E.C.
- 8. MOUNTING HEIGHTS FOR ALL WALL MOUNTED DEVICES SHALL BE FROM FLOOR TO BOTTOM OF DEVICE BOX
- 9. ALL 125 VOLT, 15&20 AMP RECEPTACLES SHALL BE LISTED TAMPER-RESISTANT RECEPTACLES (2015 N.E.C., ART. 406-11)
- 10. ALL CIRCUITS SHALL BE PROTECTED BY A LISTED ARC-FAULT CIRCUIT INTERRUPTER (COMB. TYPE)
- 11. REMOVE ALL GROUNDING BONDS FROM APPLIANCES.





100A, 120/240V, 1 DIA, 3w 60Hz Panelboard c/w 2p 60A MLO NEMA3r 2" EMT Stub Down Incoming Power

Leg	Wire	скт	Load Name		Rating/ # Poles	Load Name	СКТ	Wire	Leg
		1	HVAC	60 A/2/	20 A/1/	Lighitng	2		
		3		-	20 A/1/	Office 1 Recept 1	4		
		5	Office 2 Recept 1	20 A/1/	20 A/1/	Offce 1 Recept 2	6		
		7	Office 2 Recept 2	20 A/1/	20 A/1/	Recepts	8		
		9	Wp Recept	20 A/1/			10		
		11					12		

#### LP-02

100A, 120/240V, 1 DIA, 3w 60Hz Panelboard c/w 2p 100A MLO NEMA3r 2" EMT Stub Down Incoming Po

Leg	Wire	СКТ	Load Name		Rating/ # Poles	Load Name	скт	Wire	Leg
		1	HVAC	60 A/2/	20 A/1/	Lighting	2		
		3		-	20 A/1/	Office 1 Recept 1	4		
		5	Office 2 Recept 1	20 A/1/	20 A/1/	Office 1 Recept 2	6		
		7	Office 2 Recept 2	20 A/1/	20 A/1/	Vanity GFCI	8		
		9	Water Heater	20 A/1/	20 A/1/	Vanity GFCI	10		
		11	Bar Sink GFCI	20 A/1/	20 A/1/	Recept	12		
		13	WP Recept	20	20	INSTAHOT	14		
		15					16		
		17					1,1,811	1111111	11111

<u>Load Calculations LP-01</u> Lighting Load 658 sqft. x 3 1 974 VA Heating Load 1 @ 10kw 10 000 VA Minimum Service Size 11 974/240 V 49.9 Amps

Load Calculations LP-02 Lighting Load 658 sqft. x 3 1 974 VA DHW 1@ 4.5kw 4 500 VA 10 000 VA 16 474 VA Heating Load 1 @ 10kw Minimum Service Size 16 474 /240 V



KEVIN



DATE:	22MAR2019	# DESCRIPTION	BY	DATE	PROJECT TITLE:		
SCALE:	As indicated 0	ISSUE FOR REVIEW 1 Revision 1	MAJ	22MAR2019 Date 1	24' X 56' OFFICE - VESTA (TRUSS)		
DRAWN BY:	MAJ 1	ISSUE FOR REVIEW	MAJ	17APR2019	, ,		
CHECKER:	2	ISSUE FOR PRODUCTION	MAJ	17APR2019	DDAMING TITLE	DDO IFOT NO	OUEST NO.
Bid #:	7171397 3					PROJECT NO:	SHEET NO:
					Electrical Notes	19503-05	E02
	SCALE: DRAWN BY: CHECKER:	SCALE: As indicated DRAWN BY: MAJ 1 CHECKER: 2	SCALE:         As indicated         0. ISSUE FOR REVIEW           1 Revision 1         1 Revision 1           DRAWN BY:         MAJ         1 ISSUE FOR REVIEW           CHECKER:         2 ISSUE FOR PRODUCTION	SCALE:         As indicated         0 ISSUE FOR REVIEW         MAJ           1 Revision 1         1 Revision 1         MAJ           1 ISSUE FOR REVIEW         MAJ           1 ISSUE FOR PRODUCTION         MAJ	SCALE:         As indicated         0.	SCALE:         As indicated         0.	SCALE: As indicated 0 ISSUE FOR REVIEW MAJ 22MAR2019 Date 1 DRAWN BY: MAJ 1 ISSUE FOR REVIEW MAJ 17APR2019  CHECKER: 2 ISSUE FOR PRODUCTION MAJ 17APR2019  DRAWING TITLE: PROJECT NO:



DESCRIPTION	SPACING	FASTENER
MOBILE FLEX TO JOIST	3" O.C. PERIMETER	16 GA. 1-1/4" X 1
FLOOR, WALL, & ROOF		
JOIST TO PLATE 2X4	3 PER JOIST	3" X .131 FRAMING NAIL
JOIST TO PLATE 2X6	3 PER JOIST	3" X .131 FRAMING NAIL
JOIST TO PLATE 2X8	4 PER JOIST	3" X .131 FRAMING NAIL
JOIST TO PLATE 2X10	4 PER JOIST	3" X .131 FRAMING NAIL
JOIST TO PLATE 2X12	5 PER JOIST	3" X .131 FRAMING NAIL
DOUBLE RIM JOIST	4" O.C. STAGGERED	3" X .131 FRAMING NAIL
DOUBLE TOP PLATE	4" O.C. STAGGERED	
3/8" OSB/PLYWOOD TO JOIST		3" X .131 FRAMING NAIL
	4" O.C. ON EDGE 8" O.C. FIELD	15 GA. 2-1/2" X 7/16" STAPLE
7/16" OSB/PLYWOOD TO JOIST	4" O.C. ON EDGE 8" O.C. FIELD	15 GA. 2-1/2" X 7/16" STAPLE
7/16" OSB/PLYWOOD TO STUD (SHEAR WALLS)		15 GA. 2-1/2" X 7/16" STAPLE
1/2" OSB/PLYWOOD TO JOIST	4" O.C. ON EDGE 8" O.C. FIELD	15 GA. 2-1/2" X 7/16" STAPLE
5/8" T&G PLYWOOD TO JOIST	4" O.C. ON EDGE 8" O.C. FIELD	15 GA. 2-1/2" X 7/16" STAPLE
	16" O.C. ON EDGE 16" O.C. FIELD	#8 X 1-3/4" WOODSCREW
3/4" 5/8" T&G PLYWOOD TO JOIST	4" O.C. ON EDGE 8" O.C. FIELD	15 GA. 2-1/2" X 7/16" STAPLE
	16" O.C. ON EDGE 16" O.C. FIELD	#8 X 1-3/4" WOODSCREW
1/2" CDX TO JOIST	6" O.C. ON EDGE 12" O.C. FIELD	7/16" X 1-1/2" STAPLE
SMARTPANEL TO STUD	6" O.C. ON EDGE 12" O.C. FIELD	WIRE COIL NAIL 2-1/4" X .092
MESA SIDING TO STUD	BOTTOM, MIDDLE, TOP EVERY LOW PANEL	1-1/2" WOODGRIP SCREW
LOW RIB SIDING TO STUD	BOTTOM, MIDDLE, TOP EVERY LOW PANEL	1-1/2" WOODGRIP SCREW
7/16" FR DECKING TO JOIST	CONTINUOUS	HENKEL MB/44 ADHESIVE
	4" O.C. ON EDGE 8" O.C. FIELD	15 GA, 2-1/2" X 7/16" STAPLE
	16" O.C. ON EDGE 16" O.C. FIELD	#8 X 1-3/4" WOODSCREW
1/2" VCG	8" O.C. ON EDGE	7/16" X 1-1/2" STAPLE
	SOLID BEAD DOWN FIELD STUD	FOAM ADHESIVE
5/8" VCG	8" O.C. ON EDGE	7/16" X 1-1/2" STAPLE
70 VCG	SOLID BEAD DOWN FIELD STUD	FOAM ADHESIVE
1/2" PLAIN GYPSUM	12" O.C. ON EDGE 12" O.C. FIELD	#6 X 1-5/8" DRYWALL SCREW
5/8" PLAIN GYPSUM		
	12" O.C. ON EDGE 12" O.C. FIELD	#6 X 1-5/8" DRYWALL SCREW
WALL TO FLOOR	48" O.C.	5/16" X 5" LAG W/ WASHER
	2 PER FRAMING CELL	3" X .131 FRAMING NAIL
WALL TO FLOOR (SHEAR WALLS)	48" O.C.	(2) - 5/16" X 5" LAG W/ WASHER
	2 PER FRAMING CELL	3" X .131 FRAMING NAIL
WALL TO WALL	24" O.C.	5/16" X 3" LAG W/ WASHER
	12" O.C.	3" X .131 FRAMING NAIL
WALL TO ROOF	48" O.C.	5/16" X 5" LAG W/ WASHER
	2 PER FRAMING CELL	3" X .131 FRAMING NAIL
WALL TO ROOF (SHEAR WALLS)	48" O.C.	(2) - 5/16" X 5" LAG W/ WASHER
	2 PER FRAMING CELL	3" X .131 FRAMING NAIL
HURRICANE STRAP TO WALL	SEE F02	1.496" FAB38V5
PLATE CHORD TO SPLICE	OF LITERED AT OR LOS	0/5 / 1/15// 70//00 5/ / 75
2X4	CENTERED AT SPLICE	3X5 MITEK TRUSS PLATE
2X6	CENTERED AT SPLICE	3X5 MITEK TRUSS PLATE
2X8	CENTERED AT SPLICE	5X6 MITEK TRUSS PLATE
X10	CENTERED AT SPLICE	5X6 MITEK TRUSS PLATE
X12	CENTERED AT SPLICE	5X6 MITEK TRUSS PLATE
DUTRIGGER TO JOIST	EVERY OUTRIGGER	1-3/8" X 3" LAG BOLT W/ WASHER
LOOR SILL TO FRAME	1 PER CORNER OF BUILDING	1-3/8" X 10" CARRIAGE BOLT
IOIST TO FRAME	EVERY 48" LENGTH OF BUILDING	1-3/8" X 10" UBOLT
HEADER DESCRIPTION	MATERIAL	1 0.0 X TO OBOLT
0-4' ROUGH OPENING	2 - 2X4 #2 SYP SANDWICH W/ 1/2" PLYWOOD	
THE NOOGH OF ENING	2 - 2X4 #2 SYP SANDWICH VV/ 1/2 PLYVVOOD 2 - 2X4 #2 SYP JACK STUD	
	2 - 2X4 #2 SYP KING STUDS	
'-6' ROUGH OPENING	2 - 2X6 #2 SYP SANDWICH W/ 1/2" PLYWOOD	











DATE:	22MAR2019 #	DESCRIPTION	BY	DATE	PROJECT TITLE:		
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Bid #:	7171397 3				Fastening Schedule	PROJECT NO.	SHEET NO
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	Bid #:	7171397 3				Foundation Page	PROJECT NO.	SHEET INC
Foundation Dr. Wago, TY 78712		4				Foundation Fage	19503-05	F0
1101 Foundation Dr., Waco, TX 76712 Tel. (254) 741-6701								



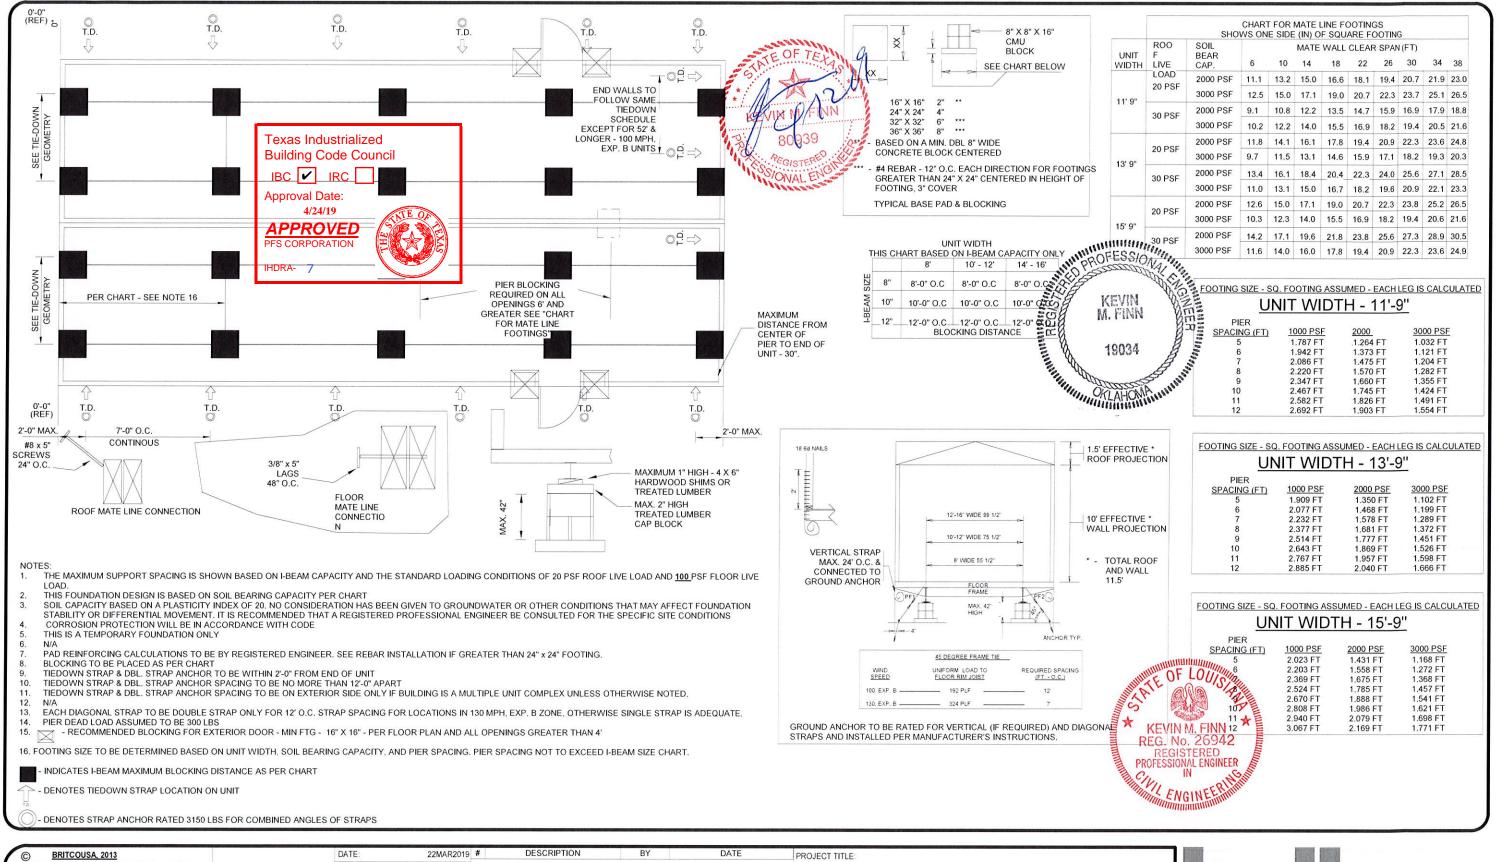

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NG FIRST OBTAINED THE EXPRESS WRITTEN CONSENT OF CO	CHECKER:	1	2 ISSUE FOR PRODUCTION	MAJ	17APR2019	DRAWING TITLE:	PROJECT NO:	SHEET NO
	Bid #:	7171397	3				PROJECT NO.	SHEETING
			4			Plumbing Plan	19503-05	MO

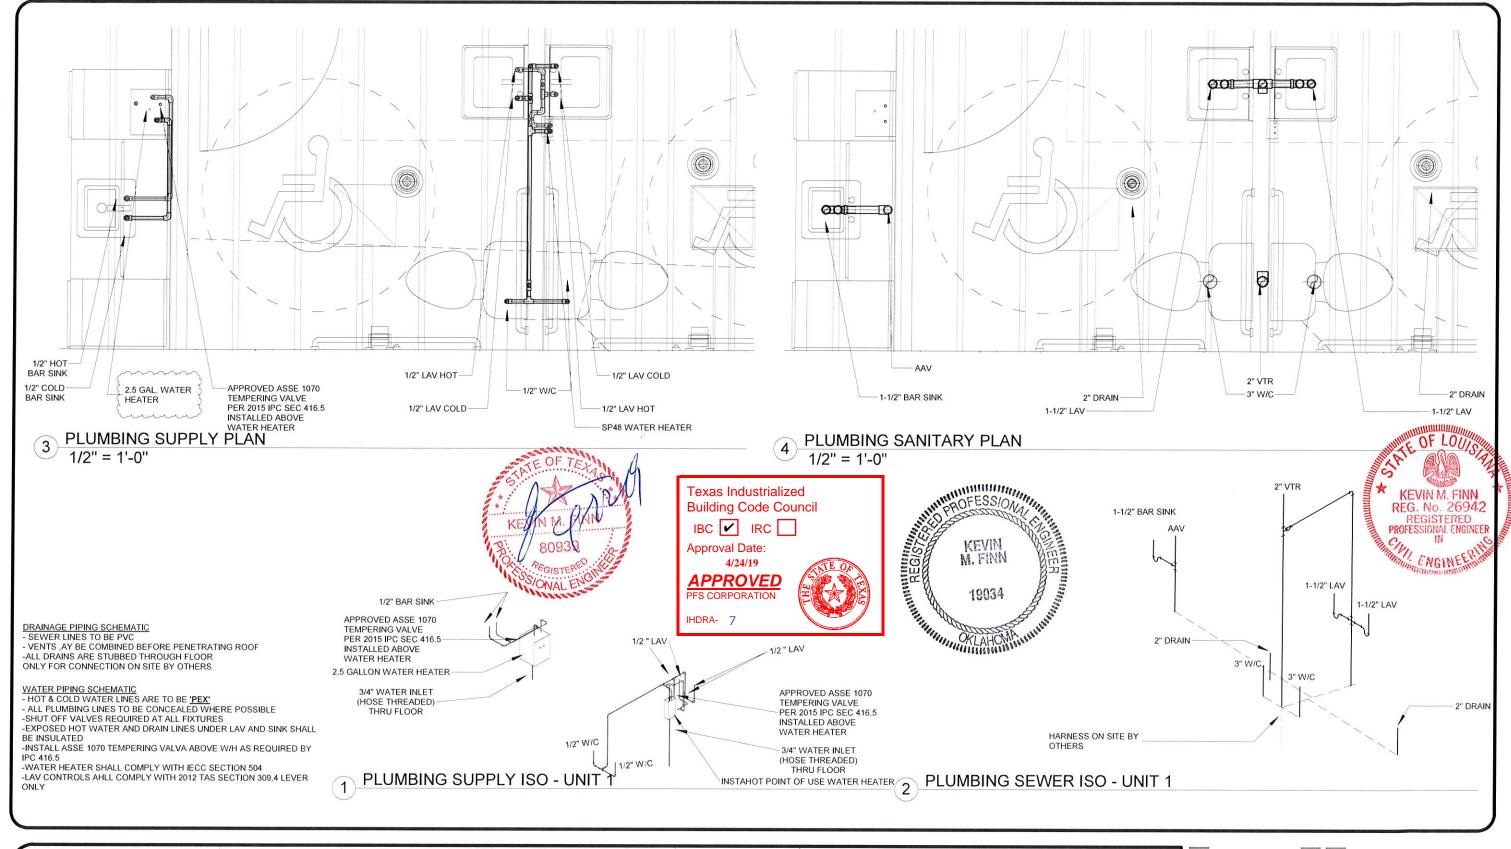

TEXAS INDUSTRIALIZED BUILDING CODE COUNCIL

This document is approved pursuant to the Industrialized Housing and Buildings

DRA No. 7 IBC X IRC

11/13/19

PROFESSION AND PROFESSION


M. FINN

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Date:

DRA Signature:


KEVIN M. FINN REG. No. 26942

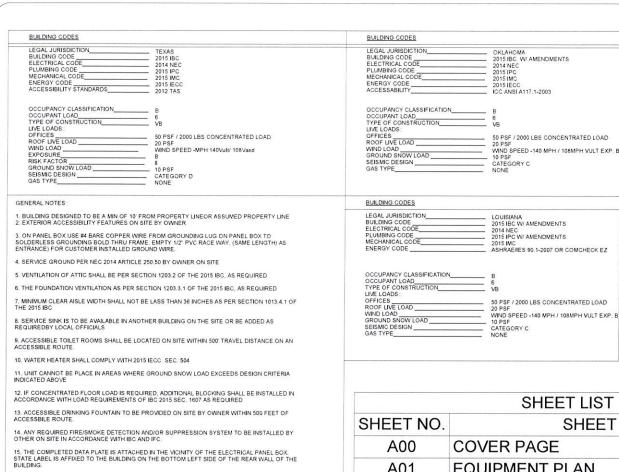

	SHEET LIST
SHEET NO.	SHEET NAME
A00	COVER PAGE
A01	EQUIPMENT PLAN
A02	FRAMING PLAN
A02.1	BLOCKING PLAN
A02.2	FLOOR FRAMING PLAN
A02.3	ROOF FRAMING PLAN
A02.4	EXT. WALL FRAMING PLAN
A04	CONSTRUCTION DETAILS
A05	MECHANICAL PLAN
D01	CROSS SECTION
D02	ELEVATIONS
D02.1	TRIM DETAILS
E01	ELECTRICAL PLAN
E02	ELECTRICAL NOTES
M01	PLUMBING PLAN

#### OPTIONS:

- SECURITY BARS
- DOOR BARS
- STEPS (PROVIDED BY CLIENT)
- MANIFOLD WASTE TO ONE DROP

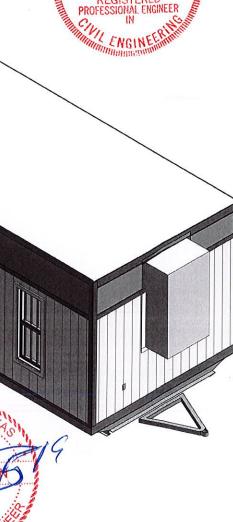

Kevin M. Finn, P.E., Inc.	
815 Waterbury Park Drive	
Elkhart, IN 46517	
TX P.E. Lic. # 8939 / Firm # F-12601	
LA P.E. Lic. # PE-0026942 / Firm # 53	353


17. IF BUILDING IS PLACE IN A WIND BORNE REGION. IT IS THE RESPONSIBILITY OF THE OWNER TO PROVIDE AND INSTALL PROTECTION OF OPENINGS, IN ACCORDANCE WITH SECTION 1609.1.2 OF THE 2015 IBC.

SQ FT = 658

OCCUPANT LOAD = 6

OK P.E. Lic. # PE-19034 / Firm #	H. AMERICANA CONTROL			200						
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	DRAWINGS SEE PROJECT	CHECKER:		2				DRAWING TITLE:	PROJECT NO:	CUEET NO
	2017-05-12X56-OFFICE	Bid #:	7171397_R3	3				COVER PAGE	PROJECT NO.	SHEET NO:
1101 Foundation Dr., Waco, TX 76712				4				COVER PAGE	2019-01	A00
Tel (254) 741-6701										



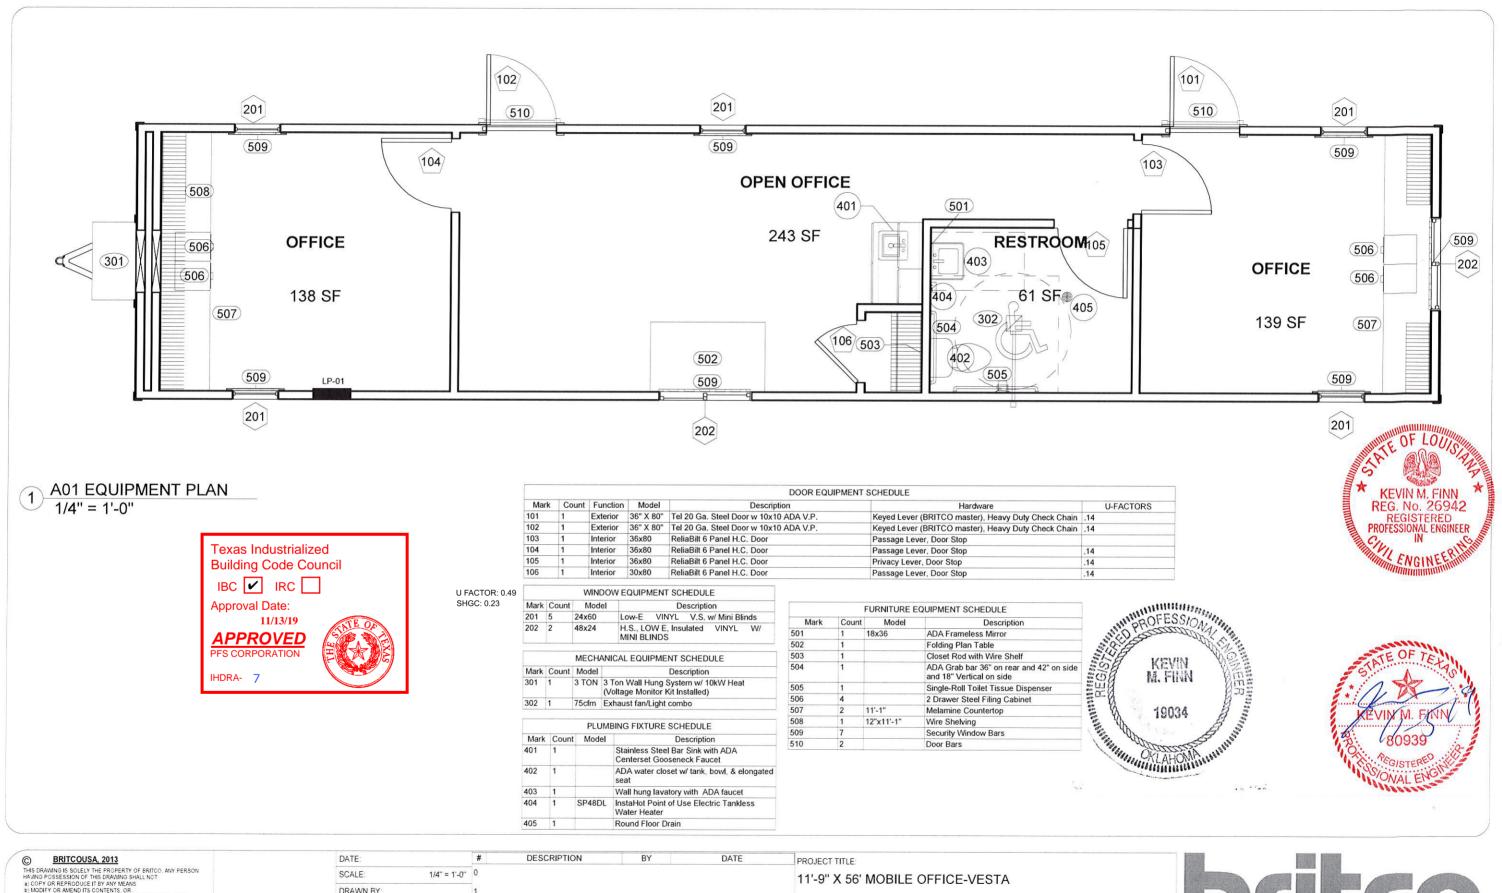



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BRITCO

Bid #: 7171397_R3 3

To let (254) 741-6701



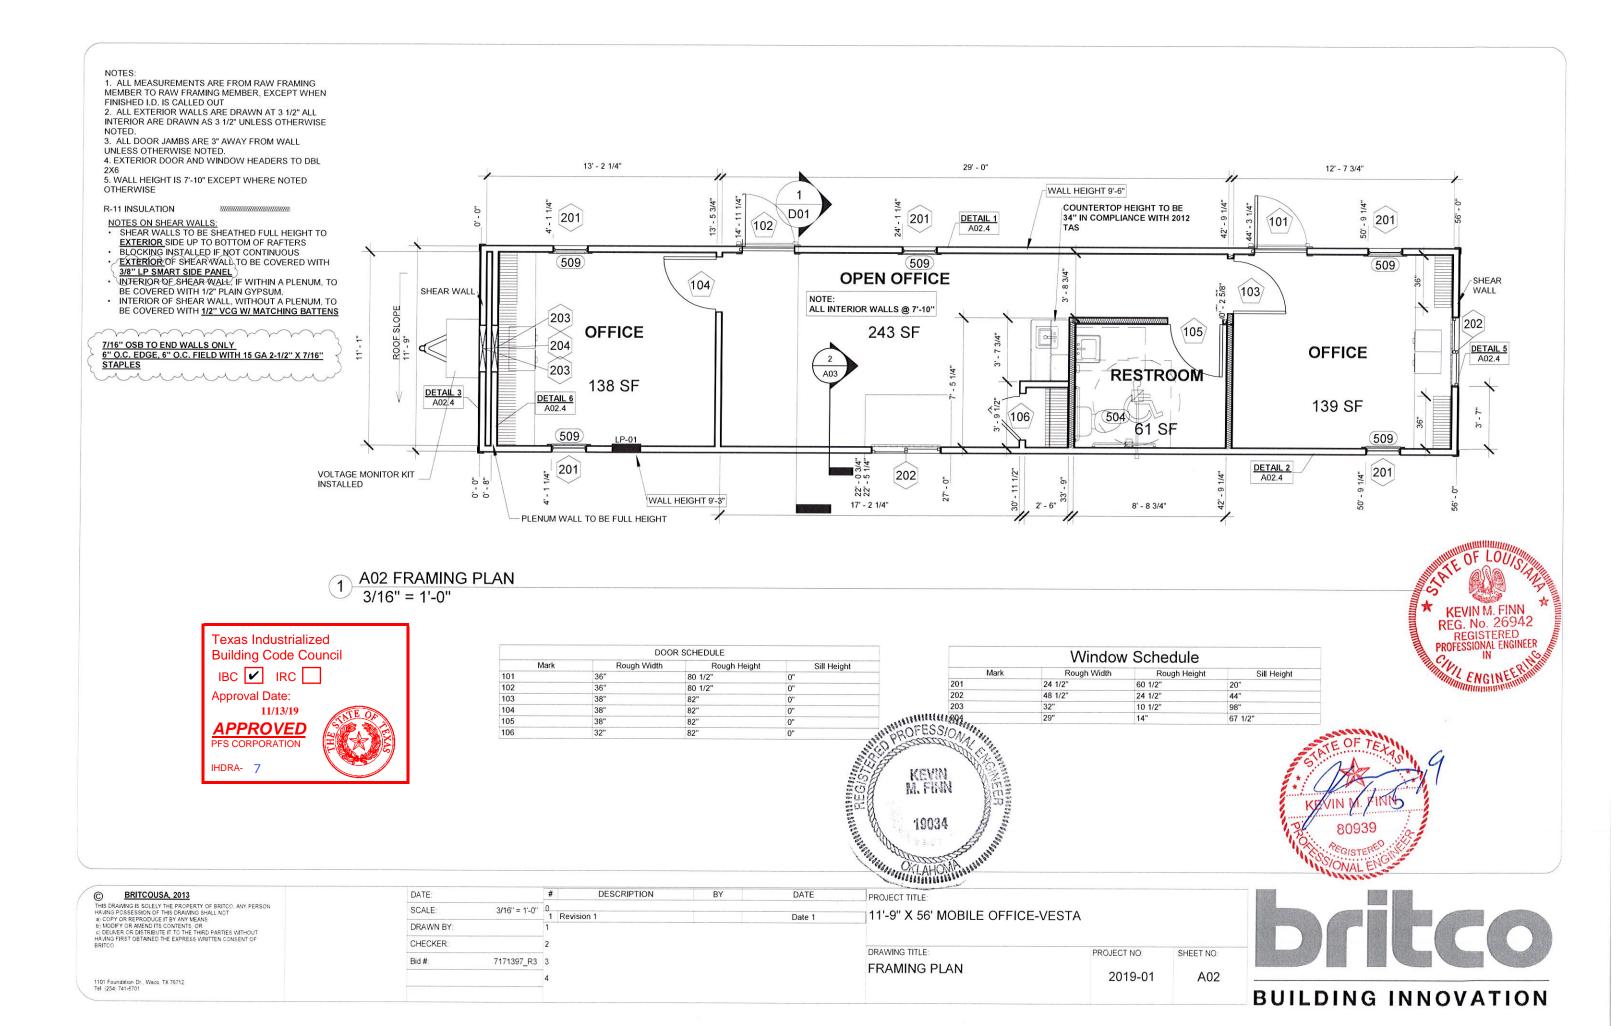

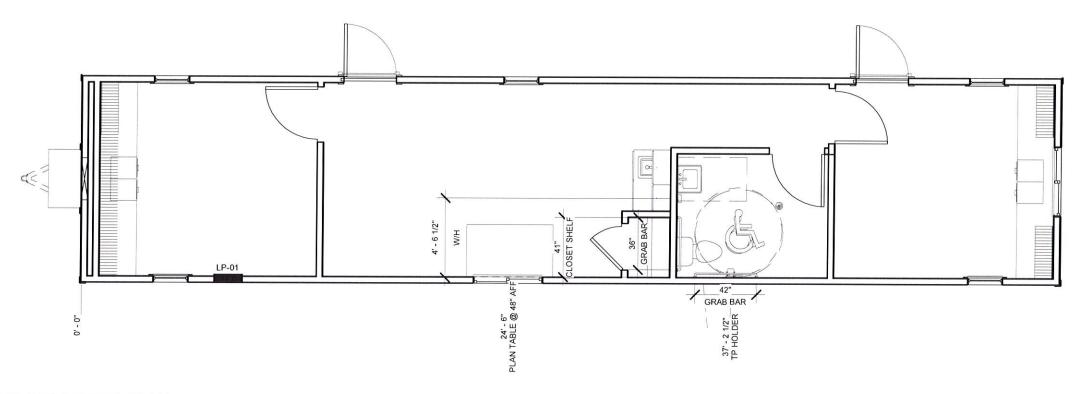



1 A02.1 BLOCKING PLAN 3/16" = 1'-0"



<u>ITEM</u>	BLOCKING HEIGHT	MATERIAL
CLOSET	66-1/2" AFF	2X6
CORK BOARD	56" AFF	2X6
LOCKERS	1-1/2" & 66-1/2" AFF	2X6
NIGHT TABLE	1-1/2" & 24-1/2" AFF	2X6
PERSONAL DESK	1-1/2" & 24-1/2" AFF	2X6
TELEVISION	60" AFF	2X8
TACK BOARD	56" AFF	2X6
FIRE EXTINGUISHER	44" AFF	2X10
WATER HEATER	42" AFF	2X8
SHAVING SHELF	30" AFF	2X6
SOAP DISPENSER	36" AFF	2X6
MOP SINK TAPS	32" AFF	2X8
TP HOLDER	20" AFF	2X6
TOWEL BAR	40-3/4" AFF	2X8
TOWEL RING	40-3/4" AFF	2X6
VANITY COUNTER	26-1/2" AFF	2X6
COAT RACK	68" AFF	2X8
PARTITION BLOCKING	24", 48" 72" 96" AFF	2X4
GRAB BARS	33-36" AFF	2X8






NOTE: GENERIC BLOCKING SCHEDULE INTENDED TO CAPTURE ALL POSSIBLE CIRCUMSTANCES NOT ALL OBJECTS MAY BE PRESENT IN UNIT

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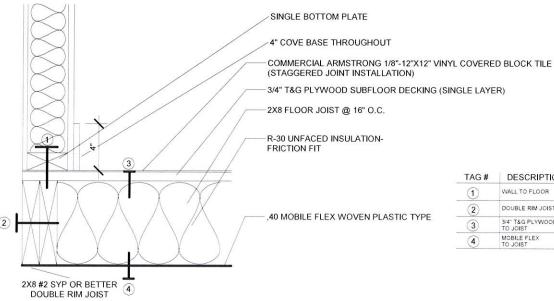
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.0011	WALAHOMINE	Ithe.



**FASTENER** Texas Industrialized 5/16" X5" LAG W/ WASHER **Building Code Council** 48" O.C. 3" X .131 FRAMING NAIL IBC ✓ IRC 🗌 3" O.C. PERIMETER Approval Date: 16 A, 1-1/4" X 1 11/13/19 **APPROVED** PFS CORPORATION

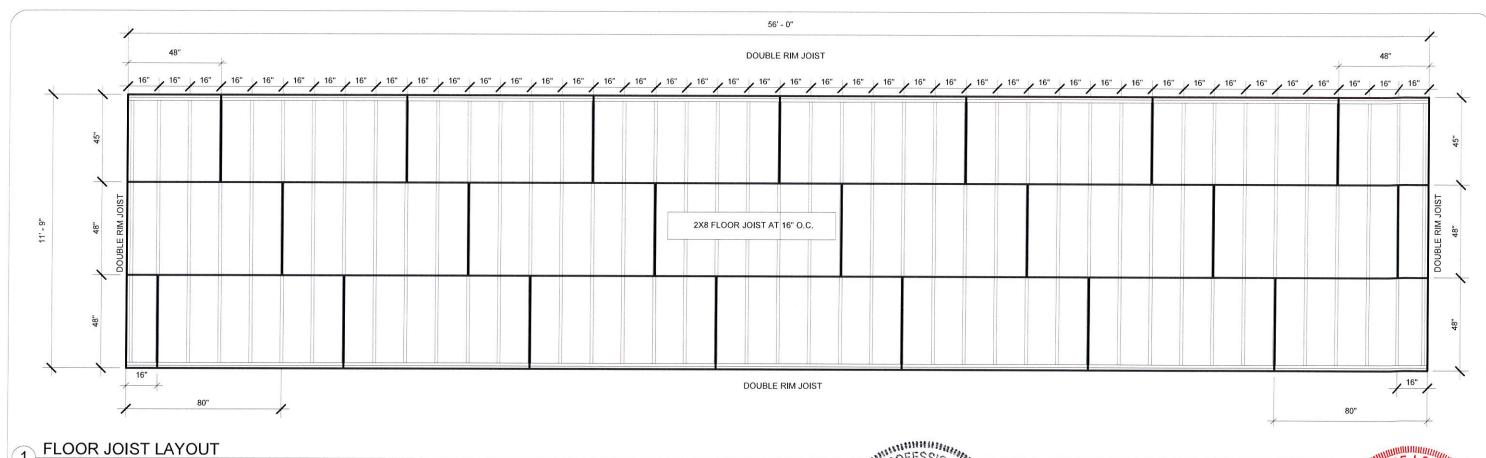IHDRA- 7



2 A02.2 FLOOR/FASTENING DETAIL 1 1/2" = 1'-0"

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MODIFY OR AMEND ITS CONTENTS, OR     CI DELINER FOR DISTRIBUTE IT OF THE THIRD PARTIES WITHOUT HAWNS FIRST OBTAINED THE EXPRESS WRITTEN CONSENT OF BRITCO	CHECKER:	2				DRAWING TITLE:	220 1507 110	0.1557.10
	Bid #: 7171397 F	3 3					PROJECT NO:	SHEET NO:
	5000	4				FLOOR FRAMING PLAN	2019-01	A02.2
1101 Foundation Dr., Waco, TX 76712 Tel. (254: 741-6701		4					2019-01	,

TAG # DESCRIPTION


WALL TO FLOOR


MOBILE FLEX TO JOIST

SPACING

4" O.C. STAGGERED



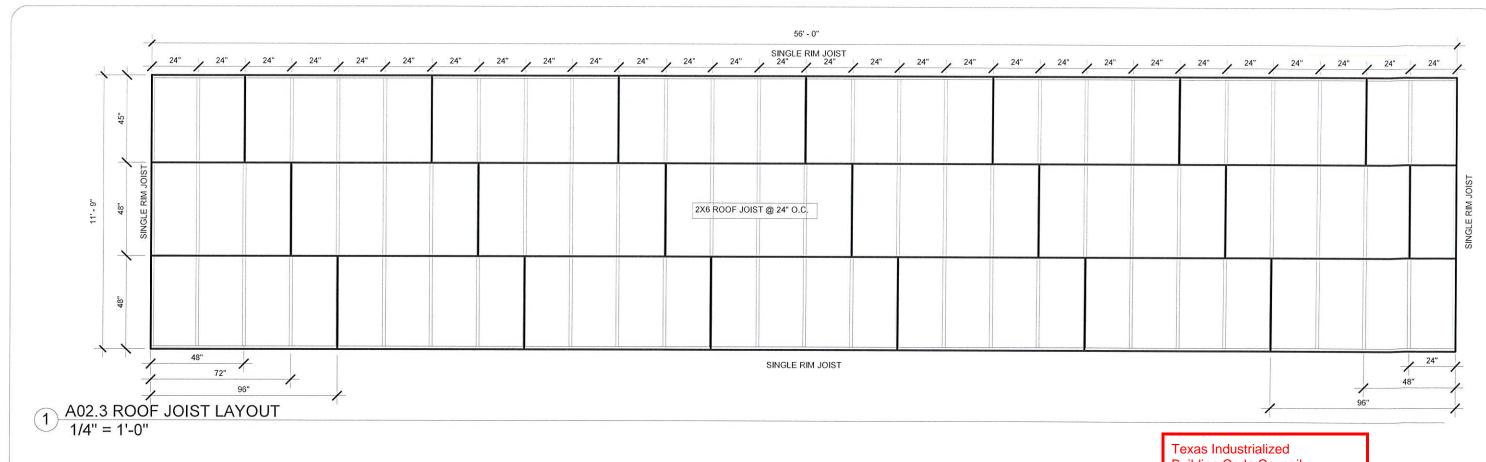

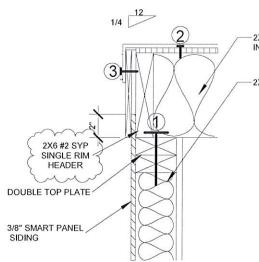

– 2X6 RAFTER SINGLE RIM JOIST @ 24" O.C. W/ R-38 UNFACED INSULATION- FRICTION FIT

2X4 STUD @ 16" O.C. W/ R-13 INSULATION

TAG#	DESCRIPTION	SPACING	FASTENER
1	DOUBLE TOP PLATE	4" O.C. STAGGERED	3" X .131 FRAMING NAIL
2	7/16" FR DECKING TO JOIST	4" O.C. ON EDGE 8" O.C. FIELD	15GA, 2-1/2" X 7/16" STAPLE
3	SMART PANEL TO STUD	6" O.C. ON EDGE 12" O.C. FIELD	WIRE COIL NAIL 2-1/4 X .092









2 A02.3 ROOF/FASTENING DETAIL 1 1/2" = 1'-0"

ERITCOUSA, 2013


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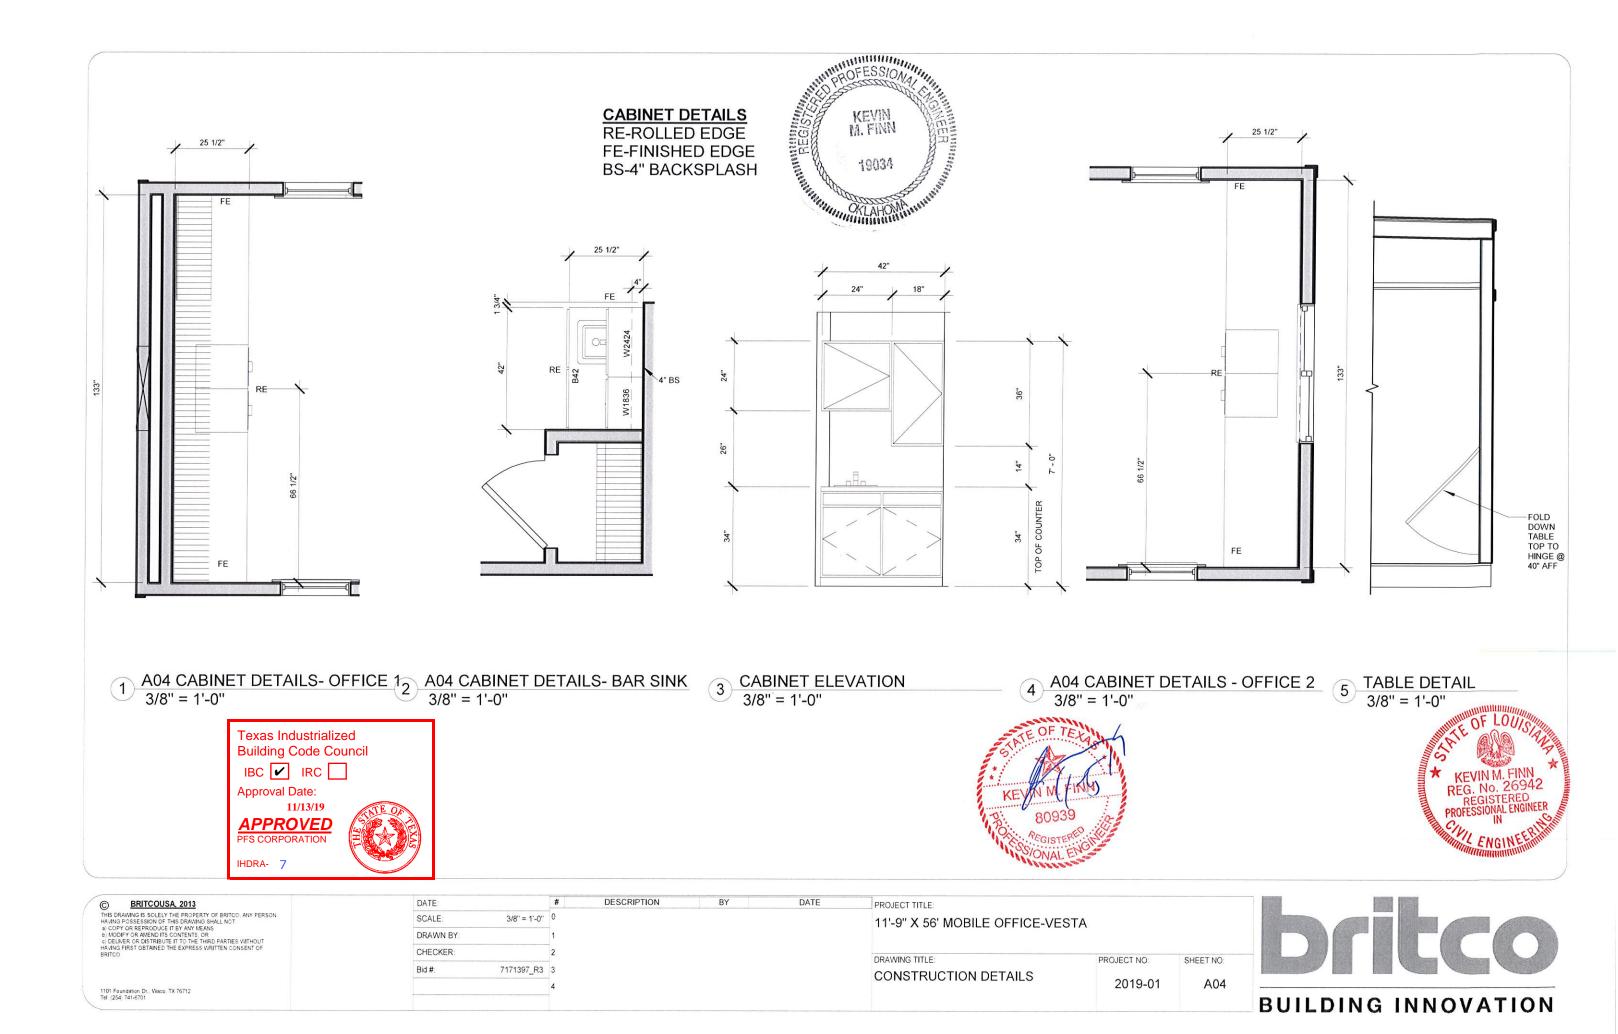
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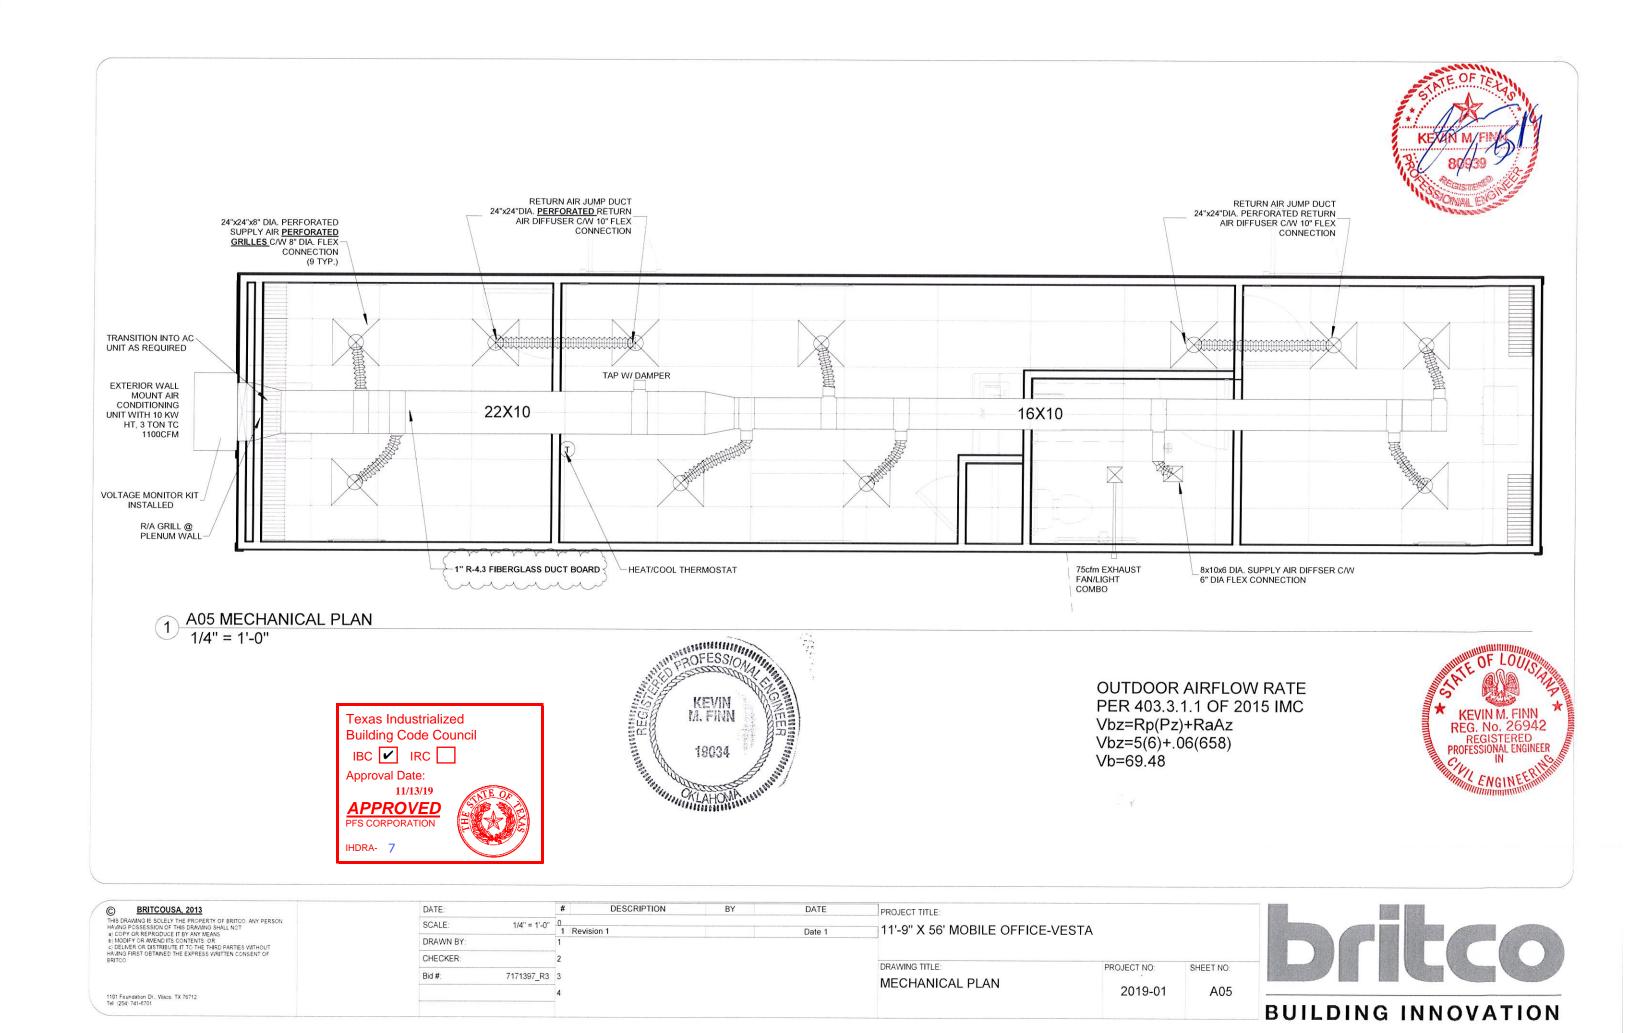
1101 Foundation Dr., Waco, TX 76712 Tel: (254) 741-6701

DATE: 5NOV1	#	DESCRIPTION	BY	DATE	PROJECT TITLE:		
SCALE: As indicated	0 1 Re	ISSUE FOR REVIEW	MAJ	5NOV19 Date 1	11'-9" X 56' MOBILE OFFICE-VESTA		
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	4				ROOF FRAMING PLAN	2019-01	A02.3
	4				TOOT TO WINTO TE UT	2019-01	








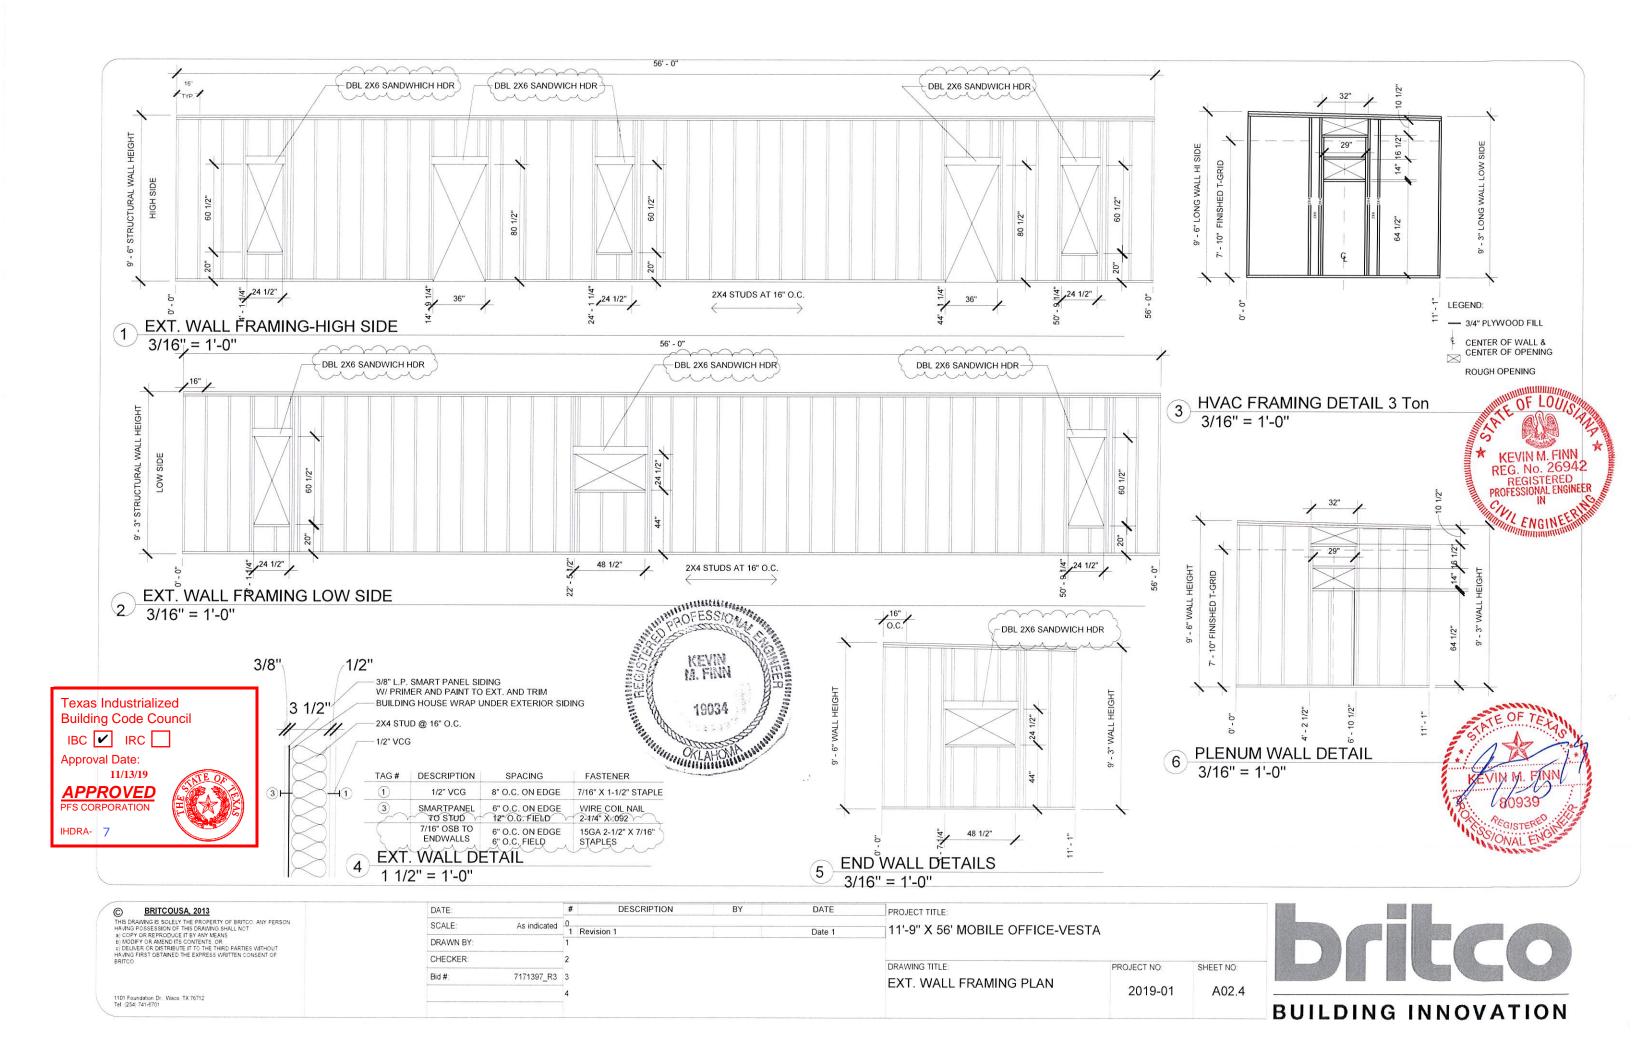



SLOPE 1/4 12

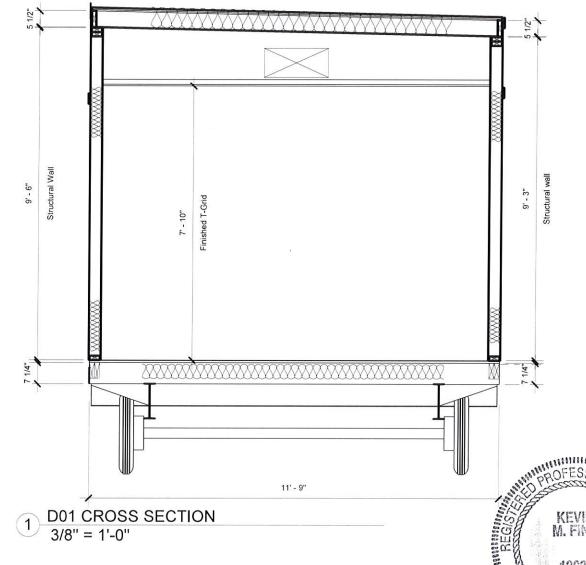

#### **FRAME**

12' X 56' 12" - I-BEAM, 1BR - 3DR AXLES, REMOVABLE HITCH, 14 PLY TIRES

#### FLOOR CONSTRUCTION

- .040 MOBILE FLEX
- 2x8 #2 SYP @ 16" O.C. DOUBLE RIM JOIST
- R-30 UNFACED INSULATION FRICTION FIT
- 3/4" T&G PLYWOOD DECKING
- 12"X12"X1/8" ARMSTRONG TILE THROUGHOUT

#### **EXTERIOR WALL**

- 3/8" SMART PANEL SIDING W/ SMART PANEL TRIM
- 2 x 4 #2 SYP @ 16 O.C.
- R-13 UNFACED INSULATION FRICTION FIT
- DOUBLE TOP PLATE
- SINGLE BOTTOM PLATE
- 1/2" VCG WITH MATCHING BATTENS
- 4" VINYL COVE BASE THROUGHOUT
- FRP LAM. TO 1/2" GYP BOARD 48" AFF BEHIND AND ADJ. TO BATHROOMS
- BUILDING WRAP
- 7/16" OSB SHEATHING TO END WALLS ONLY

#### **INTERIOR WALLS**

- 2 x 4 #2 SYP @ 16 O.C.
- SINGLE TOP PLATE
- SINGLE BOTTOM PLATE
- 1/2" VCG WITH MATCHING BATTENS
- 4" VINYL COVE BASE THROUGHOUT
- FRP @ 48" BEHIND AND BESIDE WET AREA
- R-11 UNFACED FIBERGLASS INSULATION FOR SOUND ATTENUATION ROOF CONSTRUCTION
- 2x6 #2 SYP @ 24" O.C.
- 2x6 #2 SYP @ 24" O.C.

  R-38 UNFACED INSULATION WITH NETTING
  - 045 WHITE EPDM SINGLE PLY EPDM FULLY ADHESIVE AND INSTALLED PER ESR 1463 WITH ALUMINUM DRIP RAIL TO PERIMETER SR:0.64 3YR / TE:0.87 3YR 3216" MULEHIDE F/R DECK ROOF SHEATING INSTALLED PER ESR 1776 2x4 T-GRID SUSPENDED CEILING (GRIDSTONE TILES TO R.R.)

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DATE: SCALE: As indicated 0 DRAWN BY CHECKER: Bid #: 7171397 R3 3 DESCRIPTION

PROJECT TITLE: 11'-9" X 56' MOBILE OFFICE-VESTA


DRAWING TITLE: **CROSS SECTION** 


DATE

PROJECT NO: SHEET NO 2019-01 D01





REG. No. 26942 REGISTERED

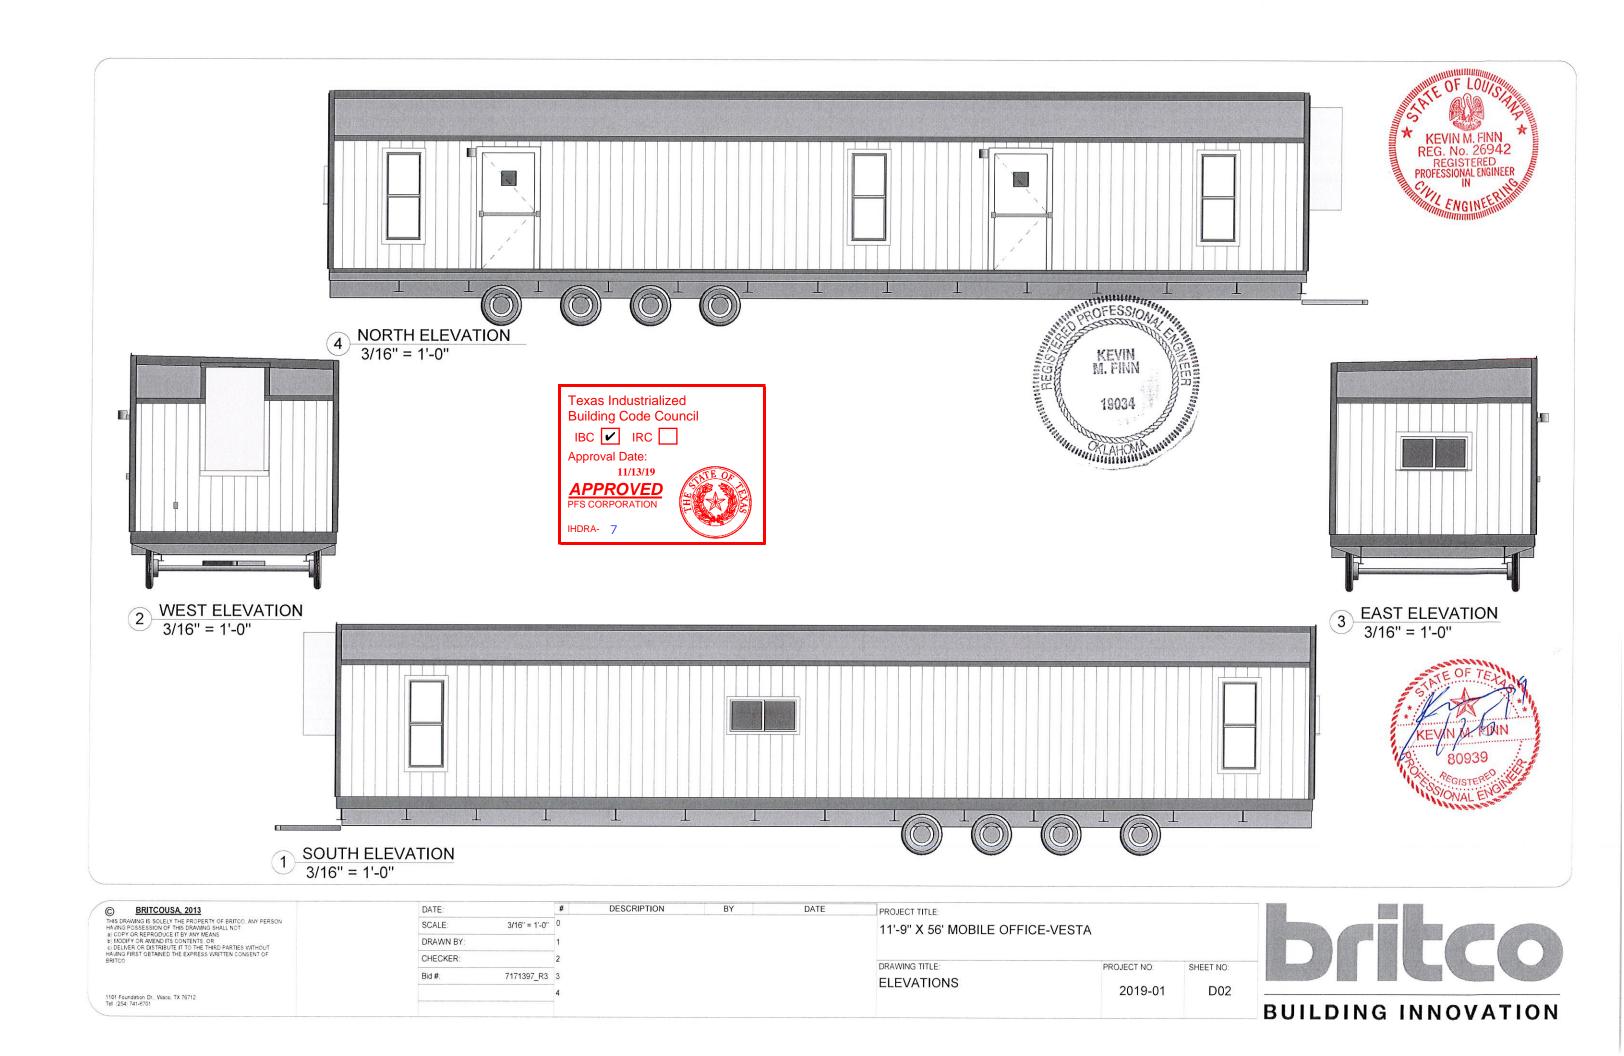

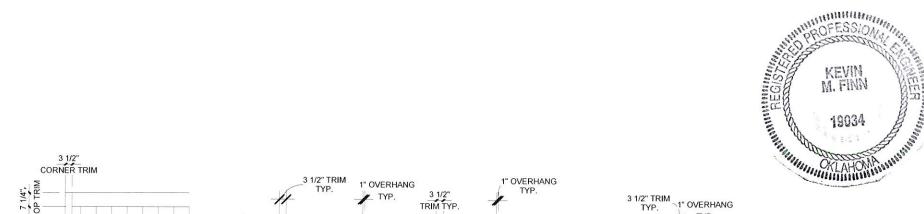


NOT ALL OBJECTS MAY BE PRESENT IN UNIT

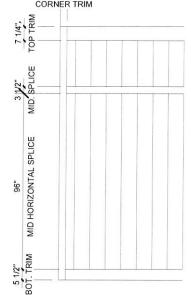

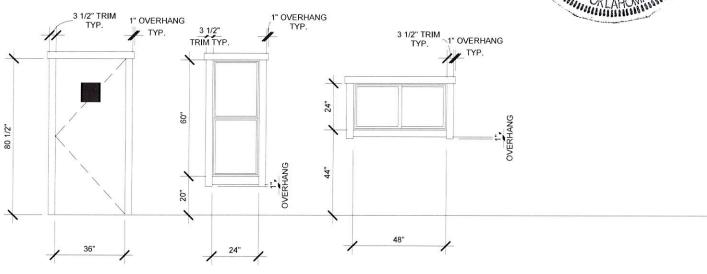


NOTE: GENERIC DOOR AND WINDOW TRIM INTENDED TO CAPTURE ALL POSSIBLE STOCK CIRCUMSTANCES

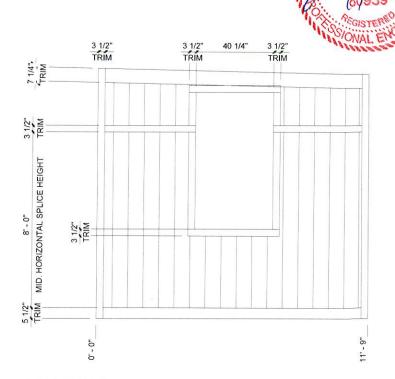


1 MANSARD TRIM 1/4" = 1'-0" 2 Door And WIndow Trim
1/4" = 1'-0"

3 HVAC TRIM 1/4" = 1'-0"

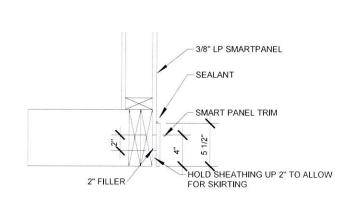

4 FLOOR TRIM DETAIL 1" = 1'-0"

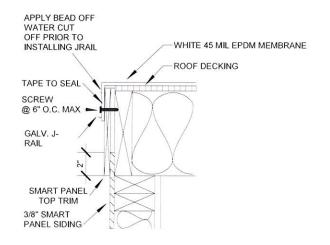


5 ROOF TRIM DETAIL 1 1/2" = 1'-0"





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	DRAWN BY:	1				o % oo oblee of fide veor		
	CHECKER:	2				DRAWING TITLE:	PROJECT NO:	SHEET NO
	Bid #: 7171397 F	3 3					PROJECT NO.	SHEET NO.
1101 Foundation Dr., Waco, TX 76712 Tel. (254) 721-8701	_	4				TRIM DETAILS	2019-01	D02.



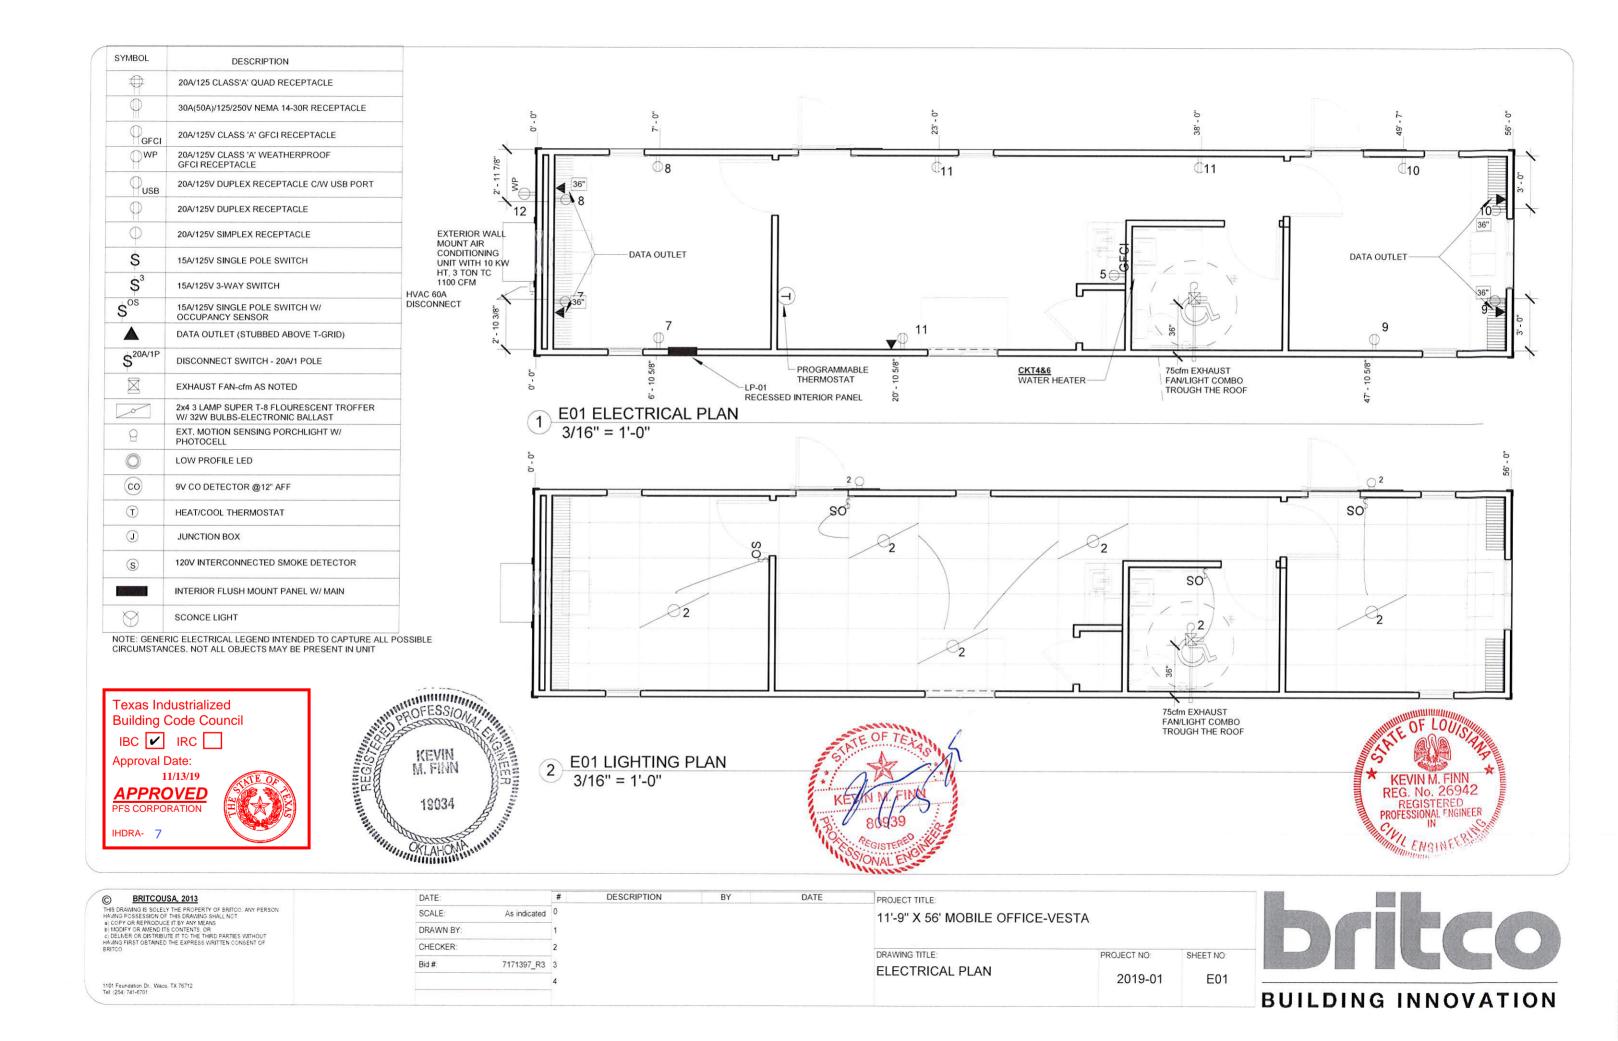

# ELECTRICAL EQUIPMENT SCHEDULE Count Project Notes Description Single Phase Panel - 120V MCB - Recessed: 100A ELECTRICAL FIXTURE SCHEDULE Project Notes Description 20A/125v Duplex Receptacle 20A/125V GFCI Recept 20a/125v Weather Proof GFCI Receptacle Data Outlet: Stubbed Up Above T-grid

	LIGHTING FIXTURE SCHEDULES	
Count	Description	Project Notes
5	2X4 4 LAMP SUPER T-8 FLOURESCENT TROFFER W 32W BULBS-ELECTRONIC BALLAST	32W
2	Ext. Motion Sensing PorchLight W/ Photocell	60W

Texas Industrialized **Building Code Council** IBC ✓ IRC Approval Date:

11/13/19


PFS CORPORATION

IHDRA- 7

	LIGHTING SWITCHES SCHEDULE	
Count	Description	Project Notes
	Lighting Switch: Vacancy Sensor	

	Mechanical Equipment	
Count	Description	Project Notes
	Bard Wall Hung Unit: 3 Ton	
	Fan light combo 75cfm: 75cfm Fan Light Combo	

HEIGHT IN INCHES	то воттом ог	BOX UNLESS OTHERWISE NOTE	ED
ELECTRICAL BOX TYPE	MTG HT (AFF)	ELECTRICAL BOX TYPE	MTG HT (AFF
WALL RECEPTACLE	16	PHONE	44
LIGHT SWITCH	44	TELE/DATA OUTLET	16
MICROWAVE RECEPT.	75	WATER HEATER	16
TV RECEPT. (TOP OF BOX)	60	EXTERIOR LIGHT	78
ANTENNA BOX	88	EXTERIOR RECEPT.	16
COMMON KITCHEN RECEPT.	44	WASHER	36
LOWER BUNK LIGHT TWIN/FULL	40	DRYER	36
UPPER BUNK LIGHT TWIN/FULL	83	THERMOSTAT - CENTERLINE	60
BUNK LIGHT DIMMER	38	OFFICE UPPER RECEPT.	38
STOVE	16	OFFICE LOWER RECEPT.	16
BEDROOM VALENCE LIGHT	60	VANITY GFI	38
DISHWASHER	XX	OFFICE DUPLEX	39

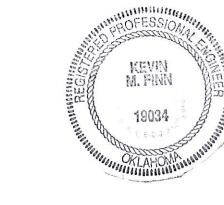






100A, 120/240V, 1 DIA, 3w, 60Hz panelboard c/w 2p 100A Main Interior Flush Mount Panel 2"EMT stub down incoming power

wire	Circuit	Load Name	<rating>/<number of="" poles="">/</number></rating>	<rating>/<number of="" poles="">/</number></rating>	Load Name	Circuit	wire
/6\	1	HVAC	60 A/2/	20 A/1/	Lighting	2	/12\
/6\	3			30 A/2/	SP48DL	4	/12\
/12\	5	GFCI	20 A/1/			6	/12\
/12\	7	Office 1	20 A/1/	20 A/1/	Office 1	8	/12\
/12\	9	Office 2	20 A/1/	20 A/1/	Office 2	10	/12\
/12\	11	Open	20 A/1/	20 A/1/	WP/GFCI	12	/12\
	13					14	

#### NOTES:

- WIRING METHOD TO BE MC CABLE, COPPER, HOME RUN TO BE EMT CONDUIT W/ COPPER WIRE, MINIMUM #
  12AWG
- 2. BLANK SPACES IN PANEL MAY BE OMITTED TO MAKE US OF SMALLER PANELS. BREAKER SIZE AND QUANTITY SHALL REMAIN THE SAME.
- ALL ELECTRICAL CONNECTIONS TO BE MOUNTED 14" AFF UNLESS OTHERWISE SPECIFIED. ALL HEIGHTS ARE MEASURED TO THE BOTTOM OF BOX.
- 4. TELE/DATA OUTLETS ARE TO HAVE A 3/4" FLEXIBLE CONDUIT STUBBED UP INTO THE CEILING SPACE UNLESS
- 5. ALL CONDUIT TO CONTAIN AN INSULATED GROUND CONDUCTOR SIZED AS REQUIRED BY 2014 N.E.C., MINIMUM # 14 AWG.
- 6. ELECTRICAL INSTALLATION SHALL BE IN COMPLIANCE WITH 2014 N.E.C.
- 7. ALL WIRING IN RETURN AIR PLENUMS SHALL MEET RATING REQUIREMENTS OF 2014 N.E.C.
- 8. MOUNTING HEIGHTS FOR ALL WALL MOUNTED DEVICES SHALL BE FROM FLOOR TO BOTTOM OF DEVICE BOX

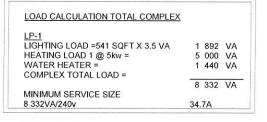

CKT	Load Name	Qty	AMPS	Phase A	Phase B
1,3	HVAC	1	41.67	41.67	41.67
2	Lighting	8	9.28	9.28	
4,6	SP48DL	1			
5	GFCI Recept	1	3.0	3.0	
7	Office 1 Recept 1	2	3.0		3.0
8	Office 1 Recept 2	2	3.0		3.0
9	Office 2 Recept 1	2	3.0	3.0	
10	Office 2 Recept 2	2	3.0	3.0	
11	Open Office Recepts	3	3.0	3.0	
12	WP/GFCI	1	1.5		1.5
Т	OTAL CALCULATED AMPS		81.45	74.95	49.17



KEVIN M. FINN REG. No. 26942 REGISTERED PROFESSIONAL ENGINEER

<b>(A)</b>	BRITCOUSA.	2012
(C)	BRITCOUSA.	2013

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Bid #:	7171397_R3	3
		4
		1

DESCRIPTION DATE PROJECT TITLE: 11'-9" X 56' MOBILE OFFICE-VESTA Revision 1 Date 1

> DRAWING TITLE: **ELECTRICAL NOTES**

PROJECT NO: SHEET NO: 2019-01 E02



**BUILDING INNOVATION** 

DESCRIPTION	SPACING	FASTENER	
MOBILE FLEX TO JOIST	3" O.C. PERIMETER	16 GA. 1-1/4" X 1	шиниции
FLOOR, WALL, & ROOF		autumu O	F LOUIS
JOIST TO PLATE 2X4	3 PER JOIST	3" X .131 FRAMING NAIL	alla 13/4
JOIST TO PLATE 2X6	3 PER JOIST	3" X .131 FRAMING NAIL  15 GA 2-1/2" X 7/16" STAPLE	
JOIST TO PLATE 2X8	4 PER JOIST	3" X .131 FRAMING NAIL	C.T.
JOIST TO PLATE 2X10	4 PER JOIST	3" X .131 FRAMING NAIL	NM. FINN
JOIST TO PLATE 2X12	5 PER JOIST	3" X .131 FRAMING NAIL	No. 26942
DOUBLE RIM JOIST	4" O.C. STAGGERED	3" X .131 FRAMING NAIL	ISTERED ONAL ENGINEE
DOUBLE TOP PLATE	4" O.C. STAGGERED	3" X .131 FRAMING NAIL	IN .
3/8" OSB/PLYWOOD TO JOIST	4" O.C. ON EDGE 8" O.C. FIELD	15 GA. 2-1/2" X 7/16" STAPLE	TRI
7/16" OSB/PLYWOOD TO JOIST	4" O.C. ON EDGE 8" O.C. FIELD	15 GA. 2-1/2" X 7/16" STAPLE	NGINEER
7/16" OSB/PLYWOOD TO STUD (SHEAR WALLS)	6" O.C. ON EDGE 6" O.C. FIELD		mimilitus.
1/2" OSB/PLYWOOD TO JOIST	4" O.C. ON EDGE 8" O.C. FIELD	15 GA. 2-1/2" X 7/16" STAPLE	
5/8" T&G PLYWOOD TO JOIST		15 GA. 2-1/2" X 7/16" STAPLE	
3/6 T&G FLTWOOD TO 30131	4" O.C. ON EDGE 8" O.C. FIELD	15 GA. 2-1/2" X 7/16" STAPLE	
3/4" 5/8" T&G PLYWOOD TO JOIST	4" O.C. ON EDGE 8" O.C. FIELD	15 GA. 2-1/2" X 7/16" STAPLE	
	16" O.C. ON EDGE 16" O.C. FIELD	#8 X 1-3/4" WOODSCREW	
1/2" CDX TO JOIST	6" O.C. ON EDGE 12" O.C. FIELD	7/16" X 1-1/2" STAPLE	litter.
SMARTPANEL TO STUD	6" O.C. ON EDGE 12" O.C. FIELD	WIRE COIL NAIL 2-1/4" X .092	SIO
MESA SIDING TO STUD	BOTTOM, MIDDLE, TOP EVERY LOW PANEL	1-1/2" WOODGRIP SCREW	DINA MA
LOW RIB SIDING TO STUD	BOTTOM, MIDDLE, TOP EVERY LOW PANEL	1-1/2" WOODGRIP SCREW	J. Bur
7/16" FR DECKING TO JOIST	CONTINUOUS	99127	IN VIC
THE THE DESTRICT OF COLOT	4" O.C. ON EDGE 8" O.C. FIELD	HENKEL MB/44 ADHESIVE  15 GA. 2-1/2" X 7/16" STAPLE  KEV	ing W
	16" O.C. ON EDGE 16" O.C. FIELD	15 GA. 2-1/2" X 7/16" STAPLE #8 X 1-3/4" WOODSCREW 7/16" X 1-1/2" STAPLE FOAM ADHESIVE	IAIA N
1/2" VCG	8" O.C. ON EDGE	7/46" V 4 4/9" CTARLE	8
1/2 VOG		7/16" X 1-1/2" STAPLE	34 B
5/8" VCG	SOLID BEAD DOWN FIELD STUD	FOAM ADHESIVE	A
5/6 VCG	8" O.C. ON EDGE	15 GA. 2-1/2" X 7/16" STAPLE  #8 X 1-3/4" WOODSCREW  7/16" X 1-1/2" STAPLE  FOAM ADHESIVE  7/16" X 1-1/2" STAPLE  FOAM ADHESIVE  #6 X 1-5/8" DRYWALL SCREW  #6 X 1-5/8" DRYWALL SCREW  5/16" X 5" I AG W/ WASHER	4
1/2" DLAIN CYDCLIM	SOLID BEAD DOWN FIELD STUD	FOAM ADHESIVE	NAA . 0000
1/2" PLAIN GYPSUM	12" O.C. ON EDGE 12" O.C. FIELD	#6 X 1-5/8" DRYWALL SCREW	10000000000
5/8" PLAIN GYPSUM	12" O.C. ON EDGE 12" O.C. FIELD	#6 X 1-5/8" DRYWALL SCREW	11 + c"
WALL TO FLOOR	48" O.C.	or to the Eric W. Witchieft	
	2 PER FRAMING CELL	3" X .131 FRAMING NAIL	
WALL TO FLOOR (SHEAR WALLS)	48" O.C.	(2) - 3/8" X 5" LAG W/ WASHER	
	2 PER FRAMING CELL	3" X .131 FRAMING NAIL	
WALL TO WALL	24" O.C.	5/16" X 3" LAG W/ WASHER	
	12" O.C.	3" X .131 FRAMING NAIL	
WALL TO ROOF	48" O.C.	5/16" X 5" LAG W/ WASHER	
	2 PER FRAMING CELL	3" X .131 FRAMING NAIL	
WALL TO ROOF (SHEAR WALLS)	48" O.C.	(2) - 5/16" X 5" LAG W/ WASHER	
,	2 PER FRAMING CELL	3" X .131 FRAMING NAIL	
HURRICANE STRAP TO WALL	SEE F02	1.496" FAB38V5	
PLATE CHORD TO SPLICE	022102	1.430 1 AB30V3	
2X4	CENTERED AT SPLICE	3X5 MITEK TRUSS PLATE	146868
2X6	CENTERED AT SPLICE	3X5 MITEK TRUSS PLATE	Et
2X8	CENTERED AT SPLICE	5X6 MITEK TRUSS PLATE	
2X10	CENTERED AT SPLICE		1.1
2X12		5X6 MITEK TRUSS PLATE	1
	CENTERED AT SPLICE	5X6 MITEK TRUSS PLATE	FINN
OUTRIGGER TO JOIST	EVERY OUTRIGGER	1-3/8" X 3" LAG BOLT W/ WASHER	
FLOOR SILL TO FRAME	1 PER CORNER OF BUILDING	1-3/8" X 10" CARRIAGE BOLT 809	39
IOIST TO FRAME	EVERY 48" LENGTH OF BUILDING	1-3/8" X 10" UBOLT(SKID ONLY)	DED .: W.
HEADER DESCRIPTION	MATERIAL	A COUNTY OF THE PROPERTY OF TH	ENGINE
0-4' ROUGH OPENING	2 - 2X4 #2 SYP SANDWICH W/ 1/2" PLYWOOD	ONAL	EW
	2 - 2X4 #2 SYP JACK STUD		200.
	2 - 2X4 #2 SYP KING STUDS		
'-6' ROUGH OPENING	2 - 2X6 #2 SYP SANDWICH W/ 1/2" PLYWOOD		
	2 - 2X4 #2 SYP JACK STUD		
	2 - 2X4 #2 SYP KING STUDS		

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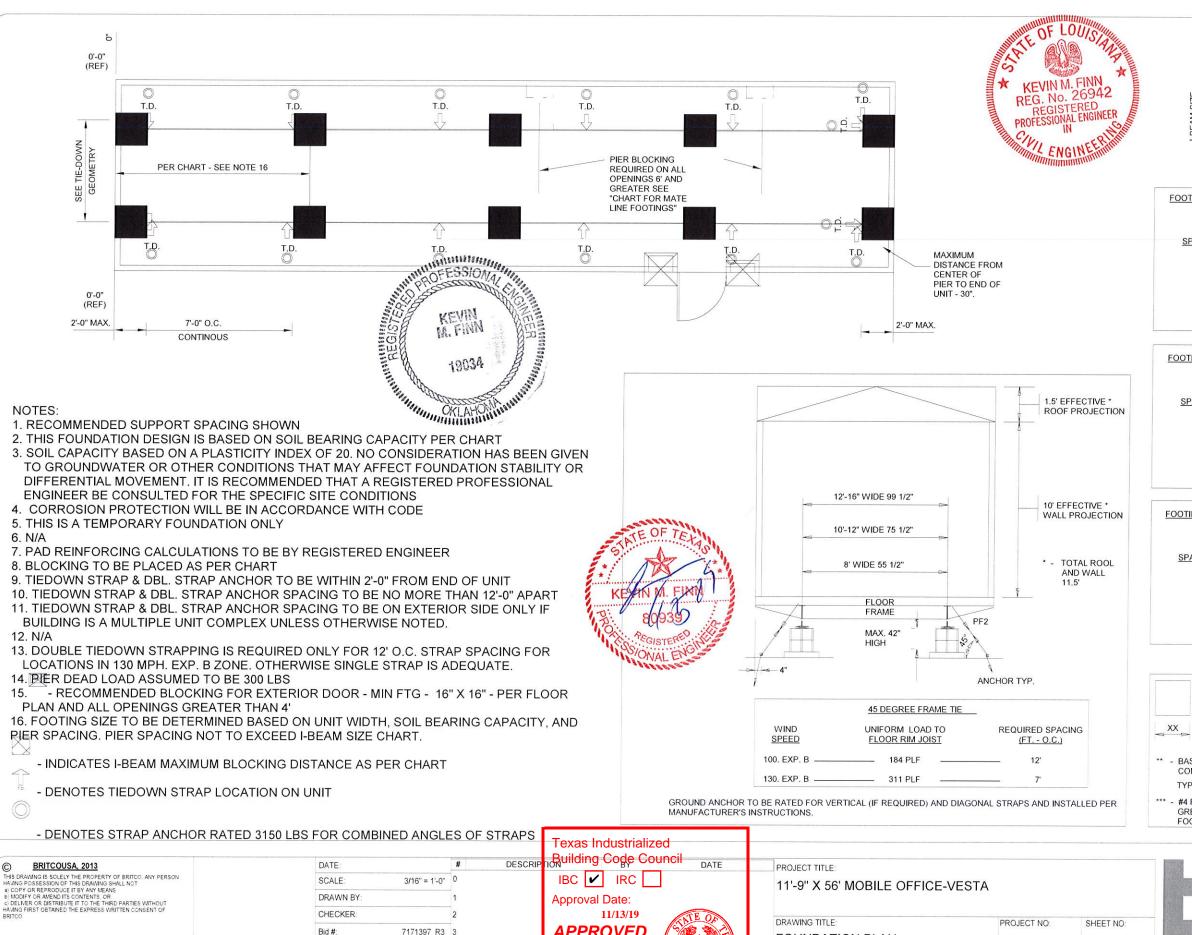
11/13/19

APPROVED PFS CORPORATION

IHDRA- 7

DATE:		#	DESCRIPTION	BY	DATE	PROJECT TITLE:		
SCALE:	3/32" = 1'-0"	0				11'-9" X 56' MOBILE OFFICE-VE	ESTA	
DRAWN BY:		1				• % •• !!!• !!! • ! ! ! ! !	20171	
CHECKER:		2				DRAWING TITLE:	DDO IFOT NO	OUEETNO
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		4				FASTENING SCHEDULE	2019-01	F01





IHDRA- 7


1101 Foundation Dr., Waco, TX 76712 Tel. (254) 741-6701

**UNIT WIDTH** THIS CHART BASED ON I-BEAM CAPACITY ONLY 10' - 12' 12' - 14' 8'-0" O.C 8'-0" O.C 8'-0" O.C 10'-0" O.C 10'-0" O.C BLOCKING DISTANCE

<u>UN</u>	<b>NIT WID</b>	<u>ΓH - 11'-</u> :	<u>9"</u>
PIER			
SPACING (FT)	1000 PSF	2000	3000 PSF
5	1.787 FT	PS64 FT	1.032 FT
6	1.942 FT	1.373 FT	1.121 FT
7	2.086 FT	1.475 FT	1.204 FT
8	2.220 FT	1.570 FT	1.282 FT
9	2.347 FT	1.660 FT	1.355 FT
10	2.467 FT	1.745 FT	1.424 FT
11	2.582 FT	1.826 FT	1.491 FT
12	2.692 FT	1.903 FT	1.554 FT

<u>UN</u>	IT WIDI	TH - 13'-9	<u>)"</u>
PIER			
SPACING (FT)	1000 PSF	2000 PSF	3000 PSF
5	1.909 FT	1.350 FT	1.102 FT
6	2.077 FT	1.468 FT	1.199 FT
7	2.232 FT	1.578 FT	1.289 FT
8	2.377 FT	1.681 FT	1.372 FT
9	2.514 FT	1.777 FT	1.451 FT
10	2.643 FT	1.869 FT	1.526 FT
11	2.767 FT	1.957 FT	1.598 FT
12	2.885 FT	2.040 FT	1,666 FT

<u>UNIT WIDTH - 15'-9"</u>						
PIER						
SPACING (FT)	1000 PSF	2000 PSF	3000 PSF			
5	2.023 FT	1.431 FT	1.168 FT			
6	2.203 FT	1.558 FT	1.272 FT			
7	2.369 FT	1.675 FT	1.368 FT			
8	2.524 FT	1.785 FT	1.457 FT			
9	2.670 FT	1.888 FT	1.541 FT			
10	2.808 FT	1.986 FT	1.621 FT			
11	2.940 FT	2.079 FT	1.698 FT			
12	3.067 FT	2.169 FT	1.771 FT			

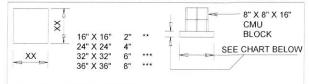


** - BASED ON A MIN. 8" WIDE CONCRETE BLOCK CENTERED TYPICAL BASE PAD & BLOCKING

*** - #4 REBAR - 12" O.C. EACH DIRECTION FOR FOOTINGS GREATER THAN 24" X 24" CENTERED IN HEIGHT OF FOOTING, 3" COVER

**FOUNDATION PLAN** 2019-01 F02



BUILDING INNOVATION

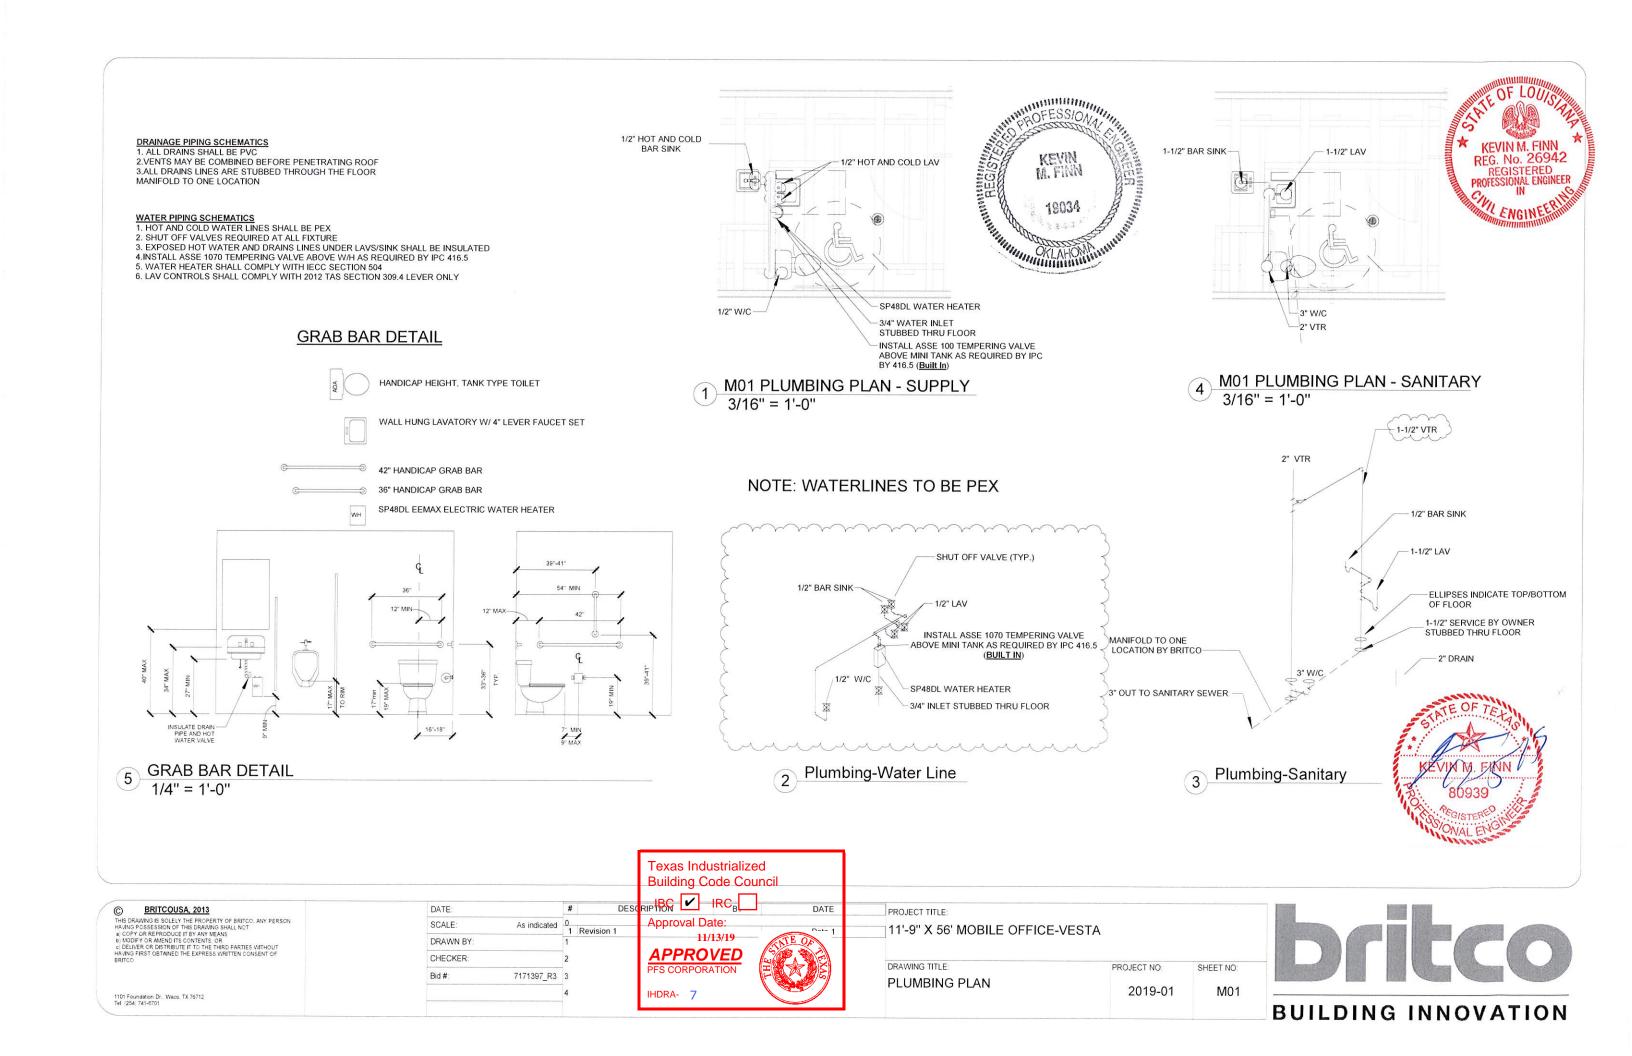

I	ERAME		
	I-BEAM OUTRIGGER CROSSHEMBER HITCH AXLES TIRES PAINT	MI2 X II.8 JR I-BEAM ASTM A-529 STEEL 48' DC. GA ASTM A-529 6-1/2' X 32 3/8' X I 1/2' STEEL 48' DC. ASTM A-529 I 1/4' X 5 1/2 X 1/4' STEEL DEMDUNTABLE VITH 2-5/16' COUPLER & ELEVATING JACK TRIPLE 6000M (2 BRAKE - I IDLER/MODULE) 800 X 14.5 X 8 PLY MINIMUM 3 MIL BLACK ASPHALT	Γ
	BOTTOM BOARD: INSULATION: JUIST: DECKING:		
	EXTERING WALLS		
	TOP PLATE:	2X4 H2 SYP OR EQUAL @ 16' D.C. (12' D.C. FIRST 3' AT CORNERS)SINGLE 2X4 H2 SYP OR EQUALB'-DL NOMINALB'-DL NOMINAL GYPSUM	
	STRING COLUD	DOUBLE 2X1 #2 SYP DR EQUAL 8-D. NOMINAL	
	TRIM COLDR:SKIRTING:	- 1.B.D. - 29 GAUGE STEEL (OPTION LP=IX6 BOTTOM & IX4 BALANCE SMART TRIM) - T.B.D. - (OPTIONAL - (20) 36X108 STEEL DR (15) 48X120 SMART PANEL	
		2X.1 H2 SYP 0 16' D.C. SINGLE H2 2X4 SYP DIDUBLE H2 2X4 SYP 8'-0' NOMINAL 1/2' VINYL COVERED GYPSUM (RESTROOM OPTION REQUIRES FRP 0 48') KATCHING VINYL WRAP R-11 UNFACED FIBERGLASS (OPTIONAL)	S B II
	RODE RAPTERSI CELLING PANEL MATING BEAM INSULATION SHEATHING  RODEING  OPTIONAL RODEING	- EXG N2 SYP @ 16' D.C20# RODF LDAD-2X6 RIM RAIL - EXA VHITE T-GRID SYSTEM VITH ACCOUSTICAL TILES (7'-10' FINISH) - 40' LAYERS 3/4' (23/32') X 24' HIGH PLYVOOD LAMINATED BEAM - 40' LINFACED FIBERGLASS VITH NETTING SUPPORT - 47' 16' NOS 24' O SPAN INDEX (35' FELT PAPER) W/8d - 6' EN 12' FN 5' EN 6' FN FIRST 5' FROM FRUNT & BACK - 26 GAUGE GALVALIME STEEL RODEINGSHEATHING 19/32' CDX PLYVOOD 24' RATED W/1/2' VOOD FIBERBOARD - GIR 7/16' MULEHIDE FR DECK) VITH 45 MIL MULEHIDE BLACK EPDM GLUED DDWN PER NDE 03-0730.06, ULIBPJ OR FL5995	BUIL THE THER PROP HAVE FACI INTE
		-(2) 3/0 X 6/8 INSULATED FLUSH 20 GAUGE STEEL WITH 16 GAUGE STEEL FRAME, LEVER PASSAGE LOCK, DEAD BOLT, CLOSURE, WEATHER STRIPPING AND ADA THRESHOLD	
	INTERIOR DOORS	-(2) 2/0 X 6/B HOLLOW CORE IMPERIAL DAK EMBOSS WITH TIMELY BROWNTONE FRAME, MORTISE HINGES & SLIDE BOLT LATCH (TEACHERS CLOSET OPTION)	
	AINDOAR	(4) 4/0 X 2/0 BRONZE FINISH HORIZONTAL SLIDER VITH DOUBLE INSULATED CLEAR LOW E GLASS, INSECT SCREEN & VOODGRAIN TRIM DUT	
		120/240 VOLT SINGLE PHASE, 3 VIRE, 60 HZ. VITH GROUND 200 AMP 120/240V NEMA 3 VITH HAIN BREAKER BY DITHERS BY DITHERS BY GITHERS BY CONTINUES TO REOFFER FLUDRESCENT TYPE (12) 4' FOUR TUBE TO REOFFER FLUDRESCENT TYPE (13) 30 VATT FLUDRESCENT VP EXTERIOR ON PHOTIO CELL (2) COMBINATION EXIT/EMERGENCY LIGHT W/BATTERY BACKUP (14) 120 VOLT 15 AMP WHITE DUPLEX GROUNDING TYPE (4) 120 VOLT VHITE TOGGLE TYPE J-BOX V/CONDUIT STUB ABOVE T-GRID FOR SITE FIRE ALARM SYSTEM J-BOX V/CONDUIT STUB ABOVE T-GRID FOR SITE COMMUNICATION SYSTEM	
	PLUMBING	J-BOX V/CONDUIT STUB ABOVE T-GRID FOR SITE COMMUNICATION SYSTEM  IF NO RESTROOM(S) PROVIDED IN BUILDING THEN ADA ACCESSIBLE RESTROOM FACILITIES TO BE PROVIDED IN AN ADJACENT BUILDING ON THE SAME PROPERTY THAT CAN ACCOMODATE THE OCCUPANCY LOAD OF THE MODULAR BUILDING	
	H.V.A.C HEATING: COULING UNIT: DUCT:	(2) 10 KV, 240 VOLT HEAT STRIP (2) 3 TON 36,000 BTU 240 VOLT SINGLE PHASE AIR CONDITIONER N/4 DIRECT R DV LATT CLESCOPE TO PHASE AIR CONDITIONER	

# SOUTHERN MODULAR INDUSTRIES

24X68 CLASSROOM 23'-6" X 64'-0" ACTUAL SIZE 1504 SQUARE FEET OCCUPANT LOAD: 74 BUILDING LOCATION: LOUISIANA SHIPPING HEIGHT = 13'-9"

- 7/16' OSB (OR LP SMART FANEL) 24' RATED SHEATHING SHALL BE SUFFICIENT FOR STRUCTUR'AL SHEER VALL REQUIREMENTS AT FASTENING SCHEDULE.
- 2. BLDCKING AND ANCHORING BELOV FRAME BY OTHERS.
- 3. DEALER SHALL BE RESPONSIBLE FOR ON SITE BARRIER FREE PROVISIONS, STEPS, RAMPS, PARKING SIGNS, ETC BUILDING APPROACH (VALK OR RAMP) WITH A MINIMUM WIDTH OF 5' AND A GRADIENT OF NOT LESS THAN 1 FOOT IN 20 FEET.
- 4. ALL LOCKS TO BE UNLOCKABLE FROM THE INTERIOR VITHOUT THE USE OF A KEY OR SPECIAL KNOWLEDGE.
- 5. CORROSION RESISTANCE FLASHING AT TOP AND SIDES OF DOORS, WINDOWS AND AT ROOF PENETRATIONS.
- ALL GLAZING WITHIN 24' OF EXTERIOR PASSAGE DOORS AND INTERIOR PASSAGE DOORS OR WITHIN 18' OF FLOOR TO BE "SAFETY GLAZED" AND SO MARKED.

DATA PLATE IS ATTACHED IN V	VIC	NITY OF	THE	ELECTRI	CAL	PANEL
STATE LABEL (IF APPLICABLE)	21	AFFIXED	IN	VICINITY	DE	THE
ELECTRICAL PANEL.					-	****

SPECIAL CONDITIONS/LIMITATIONS
BUILDING GOOD FOR IECC ZC'E 1 THRU 7.
FIRE ALARM SYSTEM IF REQUIRED BY LOCAL TO BE PROVIDED AND
INSTALLED BY DITHERS AT SITS PER LOCAL CODE REGULATIONS.
IBC PER SECTION 1609.14 EXCEPTION - 7/16' DSB COVER PANELS FOR
WINDOWS TO BE SUPPLIED AT SITE BY DITHERS.
BOTTLE WATER COOLER (S) PROVIDED AT SITE BY DITHERS.
MOP SINK PROVIDED AT SITE BY DITHERS.

HLDING CODE NOTES
#E JOB SPECIFICATIONS SUPTOMEDE THE DETAIL SPECIFICATIONS WHERE
#ERE IS A CONFLICT, BUILDING OF DE LOCATED MINIMUM 20' FROM EXISTING
ROPERTY LINE, BUILDINGS ON THE SAME PROPERTY SHALL BE ASSUMED TO
AVE A PROPERTY LINE BETWE 15 THEN THE BUILDING EXTERIOR AND THE
ACILITIES WITHIN THE BUILDING SHALL BE INDENTIFIED WITH THE
NTERNATIONAL SYMBOL OF ACCESSIBILITY (BY OTHERS).

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4/6	REFLECTIVE CEILING - MECHANICAL	2/21/09
5/6	CROSS SECTION - ELEVATIONS - FASTENING - DETAILS	2/21/09
6/6	SUGGESTED BLDCKING PLAN	2/21/09

DESIGN PARAMETERS
DCCUPANCY GROUP E
CONSTRUCTION TYPE VB

DESIGN CRITERIA ROOF LIVE LOAD: ROOF DEAD LOAD: FLOOR LIVE LOAD: 10 PSF 50 PSF FLUDR LIVE LUADI 30 PSF
FLUDR DEAD LUADI 10 PSF
WIND HORIZONTAL 130 MPH, EXPOSURE "C" 359
SEISMIC ZONE SS=0.9199 S1=0.2769
SEISMIC DESIGN CAT D, SITE CLASS D SEISMIC GROUP 3

LDUISIANA CODES
2005 NATIONAL ELECTRICAL CODE
2006 INTERNATIONAL BUILDING CODE (EXCLUDING
CHAPTERS 1, 11, 27 AND 29)
2006 INTERNATIONAL MECHANICAL CODE
2000 LOUISIANA STATE PLUMBING CODE
2006 INTERNATIONAL FUEL & GAS CODE
2004 ENERGY CODE ASHRAE 90.1



REVIEWED FOR STATE FIRE MARSHAL AS PER REVIEW LETTER BY: ERIC L. PARNELL, ARCHITECT Esis Flores

362203

REVIEWED FOR COMPLIANCE with the LOUISIANA INDUSTRIALIZED BUILDING ACT




COVER - SPECIFICATIONS

SOUTHERN MODULAR INDUSTRIES





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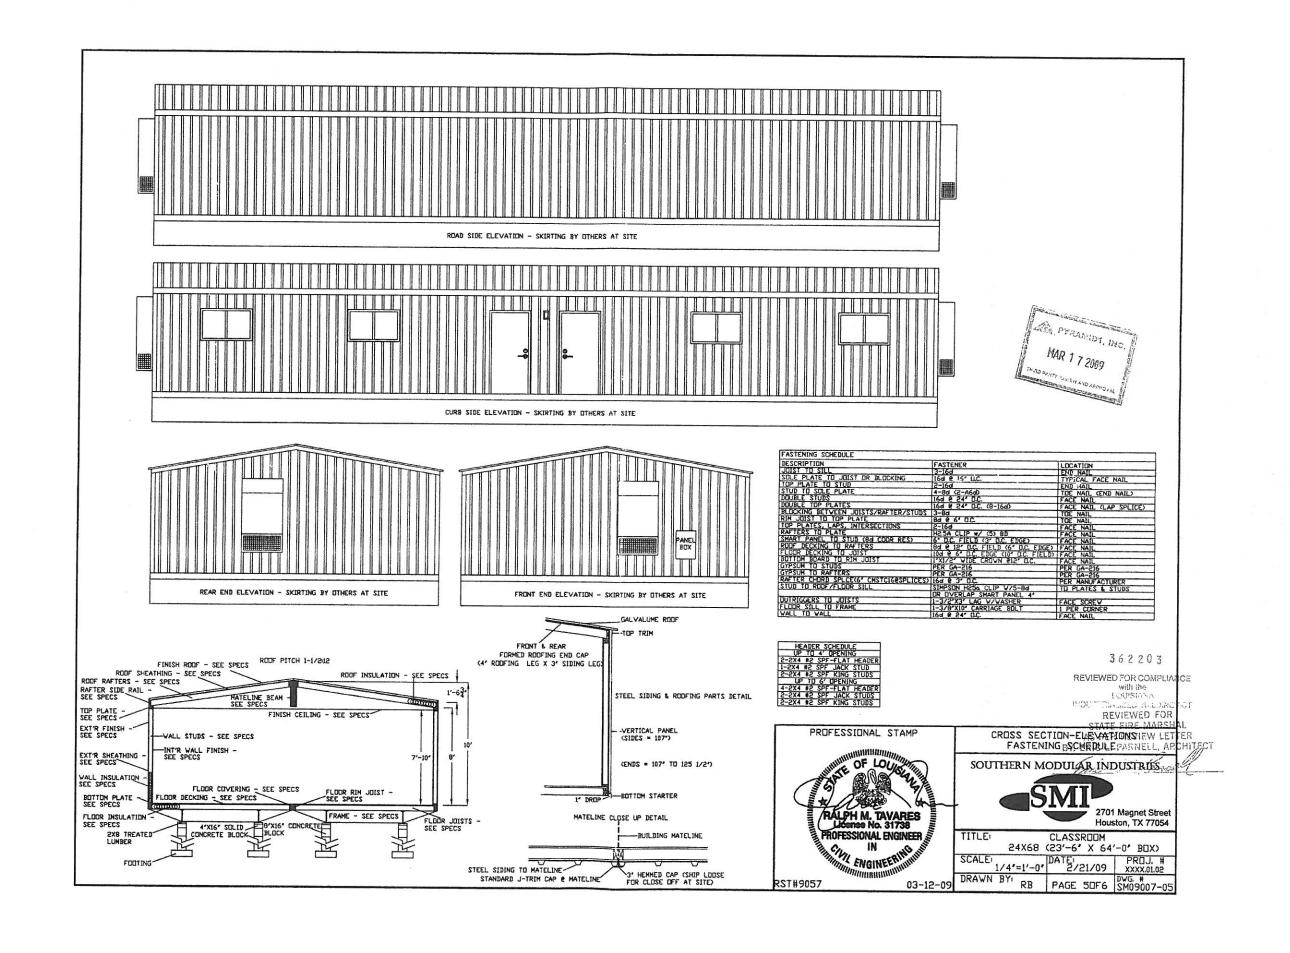
CLASSROOM 24X68 (23'-6' X 64'-0' BDX) 1/4'=1'-0' DATE' PROJ. # xxxx.01.02 DRAWN BY: RB PAGE 10F6 SM09013-01

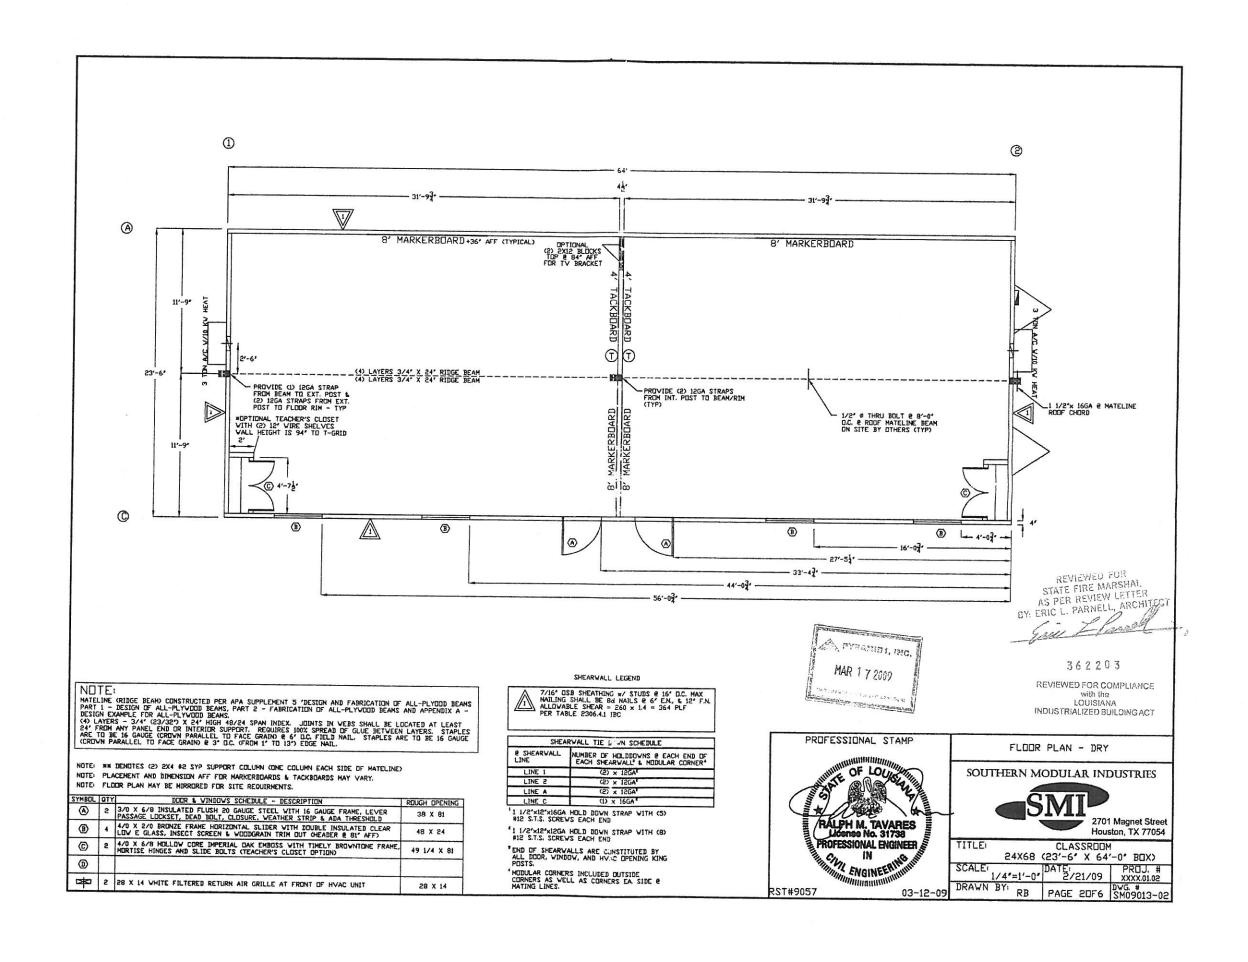


New TABLE 310.16



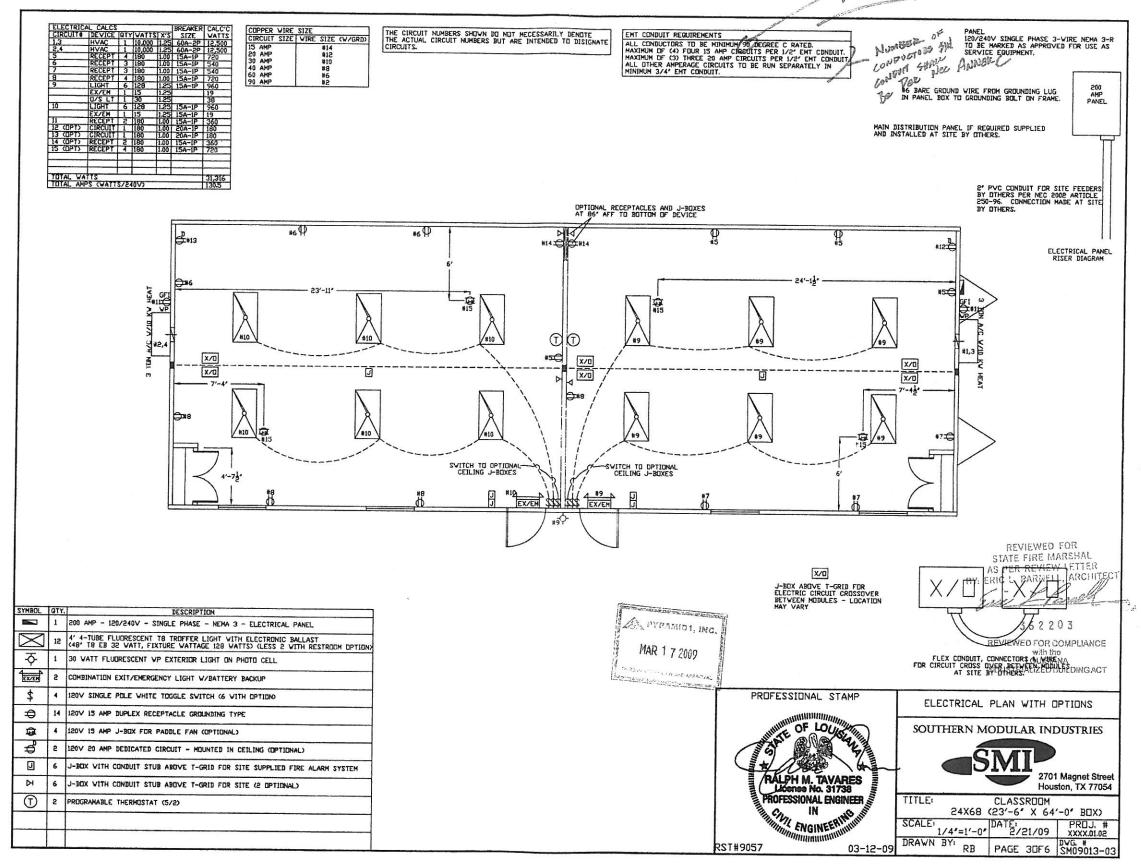

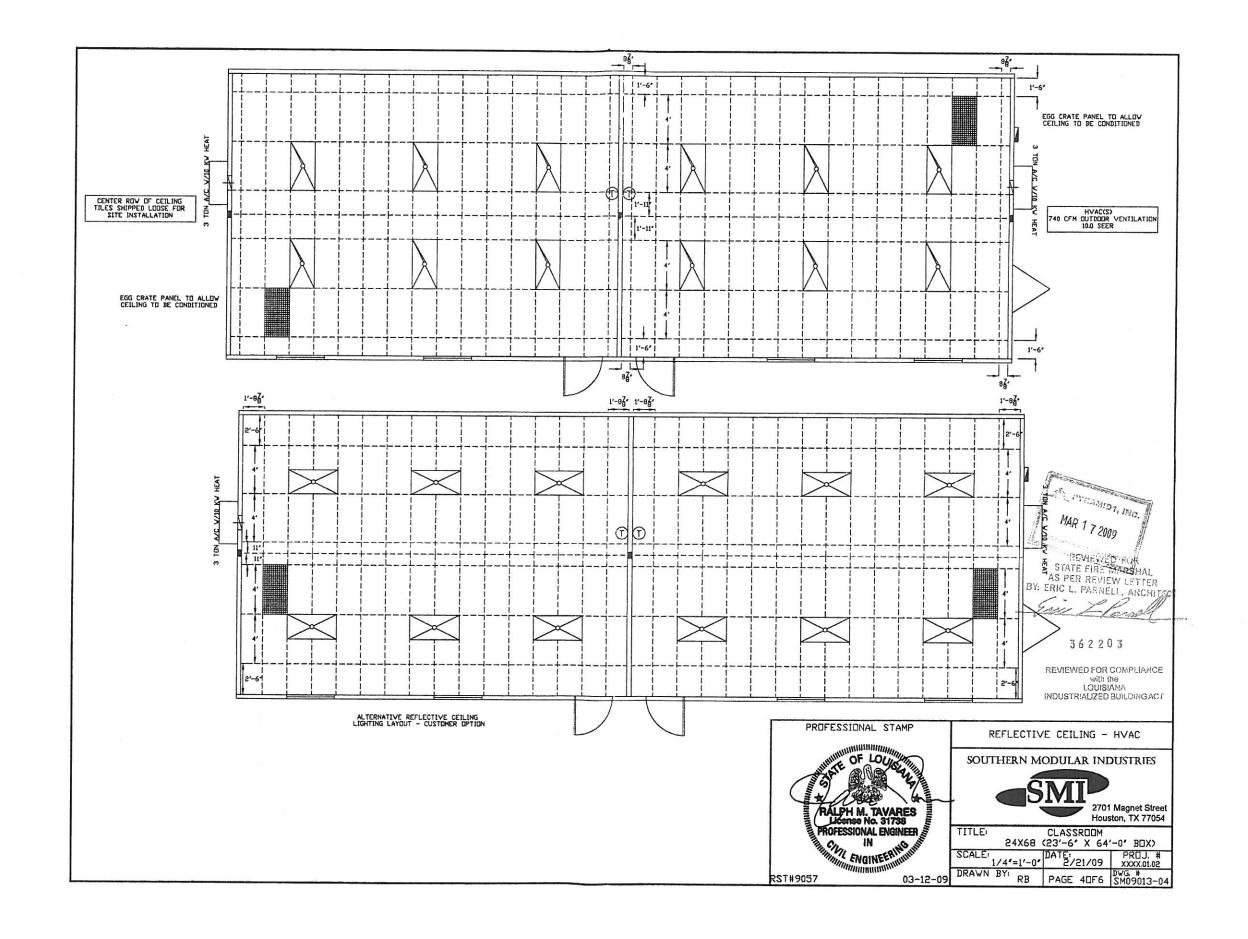

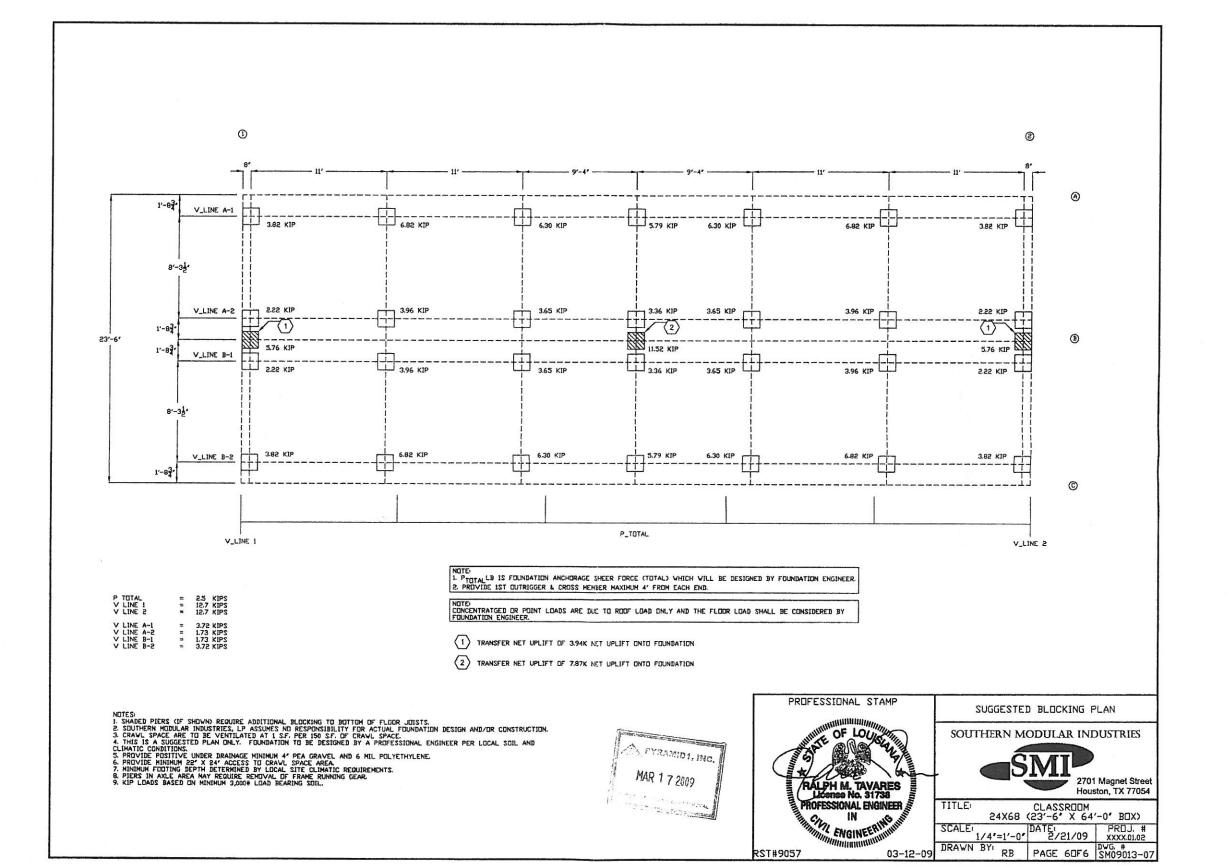

#### SOUTHERN MODULAR INDUSTRIES

12X52 RESTROOM
11'-9' X 48'-0' ACTUAL SIZE
564 SQUARE FEET
OCCUPANT LOAD: 14
BUILDING LOCATION: LA - TX - DK
SHIPPING HEIGHT = 13'-6'

#### UILDING CODE NOTES

- L 7/16' DSB 24' RATED SHEA' HING SHALL BE SUFFICIENT FOR STRUCTURAL SHEER WALL REQUIREMENTS AT FASTENING SCHEDULE.
- 2. BLOCKING AND ANCHORING BILDY FRAME BY OTHERS.
- DEALER SHALL BE RESPONSIBLE FOR ON SITE BARRIER FREE PROVISIONS, STEPS, RAMPS, PARKING SIGNS, ETC – BUILDING APPERDAC (VALK OR RAMP) VITH A MINIMUM VIDTH OF 5' AND A GRADIENT OF NOT LESS THAD I FOOT IN 80 FEET.
- 4. ALL LOCKS TO BE UNLOCKABLE FROM THE INTERIOR WITHOUT THE USE OF A KEY OR SPECIAL KNOWLEDGE.
- S. CORROSION RESISTANCE FLASHING AT TOP AND SIDES OF DOORS, VINDOWS AND AT ROOF PEW TRATIONS.
- ALL GLAZING VITHIN 24' DI EXTERIOR PASSAGE DOORS AND INTERIOR PASSAGE DOORS DI VITHIN 18' DF FLOOR TO BE 'SAFETY GLAZED' AND SD MYRKED.

DATA PLATE IS ATTACHED IN VICINITY OF THE ELECTRICAL PANEL. STATE LABEL (IF APPLICABLE) IS AFFIXED IN VICINITY OF THE ELECTRICAL PANEL.

SPECIAL CONTINUAL HITATIONS
SPECIAL CONTINUAL HITATIONS
SPECIAL CONTINUAL HITATIONS
SPECIAL CONTINUAL TO BE PROVIDED AND
FOR ALABO THE RECEDIT FOR LOCAL CODE REGULATION.
INC. PLAN STATEMENT STILL PER LOCAL CODE REGULATION.
INC. PER SECTION 1699L4 DOCEPTION - 7/16* GBS GOVER PANELS FOR
VIDROUS TO BE SUPPLIED AT JUE BY OTHERS (IF APPLICABLE).
BOTHLE WATER COLLER GS PROVIDED AT SITE BY OTHERS.
MOS SIMP ROVIDED AT SITE J' CHERK.

BULLDING CODE NOTES
THE JIBS SPECIFICATIONS SUPERIOR THE DETAIL SPECIFICATIONS VHERE
THOSE IS A CONFLICT BUILDING OF BE LOCATED MINIBUM OF FROM EXISTING
PROPERTY LINE, BULLDINGS ON A COMME PROPERTY SHALL BE ASSUMED TO
HAVE A PROPERTY LINE BUTCHED SHACK THE BUILDING EXTREMOR AND THE
FACILITIES WITHIN THE BUILDING SHALL BE DISCUSTED WITH THE
MICRORATIONAL STRIDEL OF ACCESSIBILITY OF OTHERS.

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4/6	PLUMBING SCHEMATICS	6/05/09
5/6	CROSS SECTION - ELEVATIONS - FASTENING - DETAILS	6/05/09
6/6	SUGGESTED BLDCKING PLAN	6/05/09

DESIGN PARAMETERS
DECUPANCY GROUP B
CONSTRUCTION TYPE VB

DESIGN CENTERIA
ROOF LIVE LOAD
SO PSF
FLOOR BEAD LOAD
10 PSF
FLOOR BEAD LOAD
10 PSF
FLOOR BEAD LOAD
10 PSF
SCISMIC ZORE SS=09199
SI=02769
SCISMIC ZORE SS=09199
SI = 02769

LOUISIANA CODES
2005 NATIONAL ELECTRICAL CODE
2006 INTERNATIONAL BUILDING CODE (EXCLUDING
CHAPTERS 1, II, 27 AND 29)
2006 INTERNATIONAL MECHANICAL CODE
2006 INTERNATIONAL MECHANICAL CODE
2006 INTERNATIONAL FUEL B. GAS CODE
2006 INTERNATIONAL FUEL B. GAS CODE
2004 ENERGY CODE ASHRAE 90.1

TEXAS CODES
2009 NATIONAL ELECTRICAL CODE
2006 INTERNATIONAL BUILDING CODE
2006 INTERNATIONAL MECHANICAL CODE
2006 INTERNATIONAL PLUBBING CODE
2006 INTERNATIONAL FUEL & GAS CODE
2006 INTERNATIONAL FUEL & GAS CODE
2006 INTERNATIONAL FUEL & GAS CODE
1994 TEXAS ACCESSIBILITY STANDARDS


LIKLAHOHA CODES
2005 NATIONAL ELECTRICAL CODE
2006 INTERNATIONAL BUILDING CODE
2006 INTERNATIONAL MECHANICAL CODE
2006 INTERNATIONAL PLUMBING CODE
2006 INTERNATIONAL FUEL & GAS CODE
NFPA 101-2000
ADRAG

367276


REVIEWED FOR
STATE FIRE MARSHAL
AS PER REVUEW LETTER
BY: ERIC 1. PARNELL, ARCHITECT


REVIEWED FOR COMPLIANCE with the LOUISIANA INDUSTRIALIZED BUILDING ACT




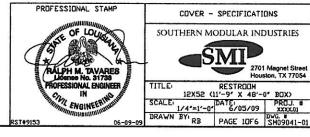



	ERAME	BUILDIN
	TRANK	1. 7/16' STRU
	DUTRIGGER	2. BLOC
	TIRES	3. DEAL
	PAINT:	PROV APPR
	BOTTOM BOARD	GRAD
	JOIST:	4. ALL
	DOTTON BOARD	320
		5. CORR
	COVERINGCOMMERCIAL (VDN)L ROLL GOODS; - SHI STANDARDS 4' VINYL COVE BASE - SHI STANDARD	6. ALL
	EXTERIOR VALLS.  57UTOS	INTER
	CHOTE THE STUDS ARE DOUBLED R 16" DC FIRST 5" AT FRONT AND BACK CORNER)	
ı	TOP PLATE:DOUBLE 2X4 #2 SYP	DATA PL
	VALL HEIGHTI9'-0' NOKINAL	ELECTRI
ı	INSULATION R-13 KRAFT FACED FIBERGLASS	SPECIAL BUILDING
	SEE SHEMMALT TANE BYCE S	FIRE AL INSTALL
	SIDING	UNDOV:
	TRIN	DUTTLE
ĺ	SKIRTING OPTIONAL SHIP LOUSE IN SHEETS	HOP SIN
ı	INTERIOR VALLS	BUILDING C
ı	BOTTOM PLATESINGLE 48 8X4 (2X6) SYP	THE JOB SE THERE IS A
ı	VALL HEIGHT	PROPERTY I
ı	23.4 (286) 82 STP 8 16" DC.  BOTTOM PLATE. SPIGE 82 SE4 (226) STP  TOP PLATE. SPIGE 82 SE4 (226) STP  VALL HEIGHT! SPIGE 82 SE4 (226) STP  VALL COVERING WHITE LEBELUVER 1/2" HR SHEETROCK TO 8"-0"  NUMBER SEA	HAVE A PR
ı	brane'	INTERNATIO
١	RAFTERS:	
ı	CEILING PANEL 2X4 WHITE VINYL FACED GYPSUH T-GRID SYSTEM-FINISH HEIGHT 7'-10'	
ı	INSULATION	D BE 3"
1	CELLING PANEL	or FROM
1	ROOFING 26 GAUGE HI RIB GALVALUME - 1-172 DVERHANG DN 48' SIDES	
ı	EXTERIOR DOORS(4) S/O X 6/8 HM 20 GAUGE STEEL VITH 16 GAUGE FRANE, FLUSH, CLOSURE, ISAA BOLT (BEST CONSTRUCTION CORE), PUSH/PULL PLATES, ADA THRESHOLD AND VEATHER STRIP	
ı		
ı	ELECTRICAL SERVICE:	
ı	LUAD CENTER (I) 100 AMP MAIN MAIN BREAKER NEMA 3 EXTERIOR TYPE	
١	RACEVAY: HINIMUM MIZ THIN AVG. COPPER V/GROUND IN ENT AND/OR NC CABLE	
I	(4) VP EXTERIOR VANDAL RESISTANT WITH 30 VATI FLUORESCENT BULB	
ı	RECEPTACLES:(4) 120 VOLT 20 AMP WHITE GFIC TYPE  (D) 120 VOLT 20 AMP WHITE GFIC TYPE - EXTERIOR MP MOUNT	
1	ELECTRICAL  SERVICE — 120/240 VOLT SINGLE PHASE, 3 VIRE, 60 HZ. VITH GROUND  LOAD CONTED — 100 AMP HAIN HAIN BREAKER HERM 3 EXTERIOR TYPE  HITCHANGED — 1-1/2" CORDUIT AT STILE 3T UITHERS  RACEVAN — HIGHMAN BIZ THAN AND, COPPER VIGINESSED IN ENT AND/OR NC CABLE  LIGHTS — 60 A" TWO TUBE 18 TROP FOR LUCROSCEDIT TYPE  (4) VECKTERIOR VANIBAL RESISTANT WITH 30 VATT FLUORESCENT BULB  RECEPTACLES: — 01 128 VILET 20 AMP WHITE GFIC TYPE — EXTERIOR VP HOUNT  SVITCHES — 60 128 VILET 13 AMP WHITE TOOGLE TYPE —	
I	PLUMBING	
i	WASTE LINES!PVC DWV-SCH 40 DRAIN-WASTE-VENT LINES (CONCEALED) STUBBED THRU FE	.DOR
I	VATER HEATER:	N AT
I	VASTE LINES - VCC BVV-SCH 40 JRAIN-VASTE-VENT LINES (CONCEALED) STURBED THRU FI VATER HARTEN - OD 126 VULT 10 BALLON TANK TYPE VITH TAR VALVE AND NETAL BRAIN PA VATER CLOSET - CS VHITE CHINA TANK TYPE VITH ASA ELDINGATED BODY, & DPEN FRONT SEAT URINAL - OD VHITE CHINA TANK TYPE VITH ASA ELDINGATED BODY, & DPEN FRONT SEAT URINAL - OD VHITE CHINA VALVE HANG VITH FLUSH VALVE	
ı	LAVATORY (12) WHITE CHINA SOXIT WALL HUNG WITH LEVER FAUCET & ADA INSULATED	PIPE VRAP
ı	ACCESSORIES:	
١	UNIDED OF WHILE CHIMA SOLIT VALL HANG WITH FLUSH VALVE ADA INSULATED ACCESSIONES:  (2) SET OF GRAD BARS - (12) 18' X 36' HERDR WITH CLIP'S SALT OFF GALVES AT FUTURES  (A) FLUOR BRAIN WITH AUTOMATIC TRAP PRIMER  (III OF THE FAMEL PRIMER CHIMA SOLIT VALVES AT FLOOR WITH AUTOMATIC TRAP PRIMER CHIMA SOLIT VALVES AT FLOOR WITH AUTOMATIC TRAP PRIMER	
۱	STEEL HODESTY PARTITIONS AND URINAL SCREENS	
١	HEATING CD 10 KV, 240 VOLT SINGLE PHASE HEAT STRIP	
١	COOLING UNIT: (I) 3 TON 36,000 BTU 240 VOLT SINGLE PHASE AIR CONDITIONERS DUCT:FOIL FACED RIGID FIBERGLASS MAIN TRINK LINE WITH A' FOIL	
1	HEATING	
۱	RETURN AID VIA VALL JUMPIES TO GYPSUM LINED PLENUM TO FRONT OF HYAC UNIT THERMISTATI OUT OF THE PROPERTY OF T	
۱	EXHAUST FANS	
1	CD 330 CFM CLILLING MOUNT ALXHAUST FAN DUCTED VITH ROOF CAP	

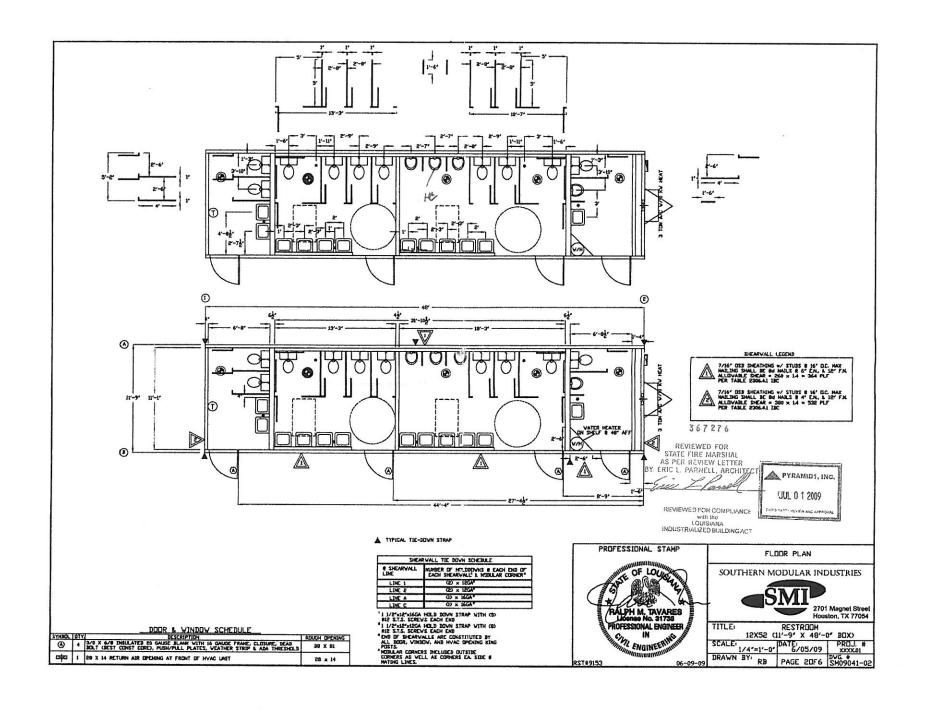

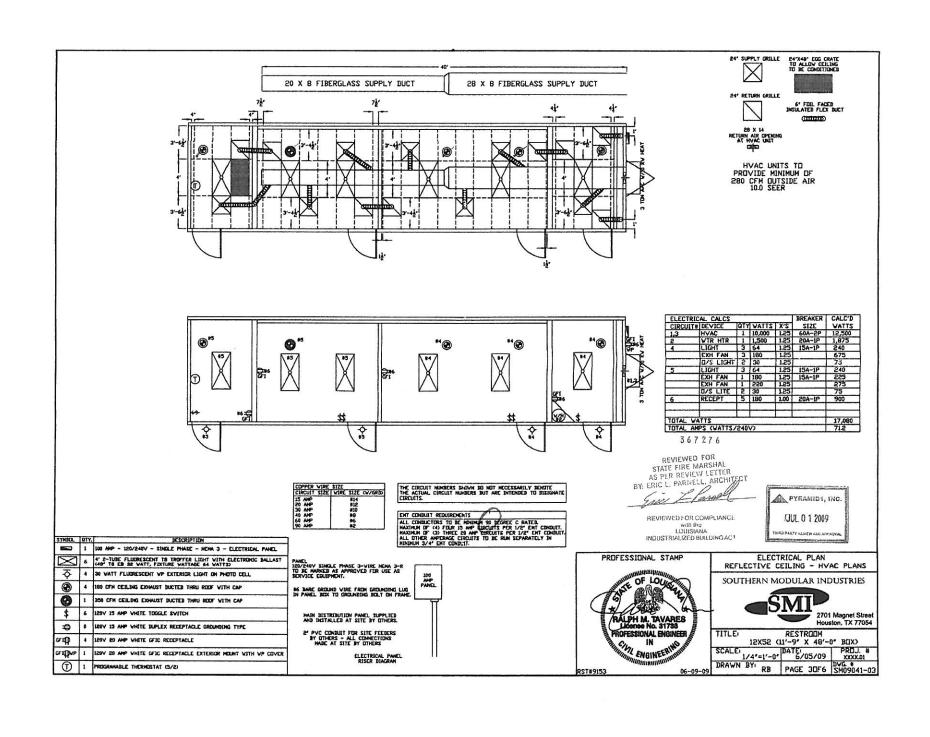

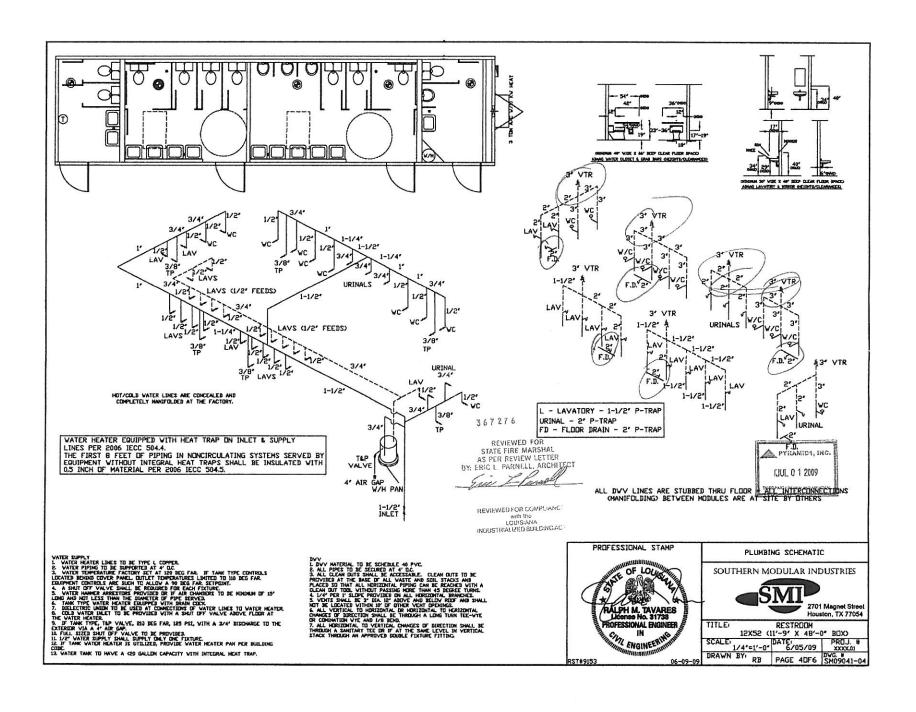

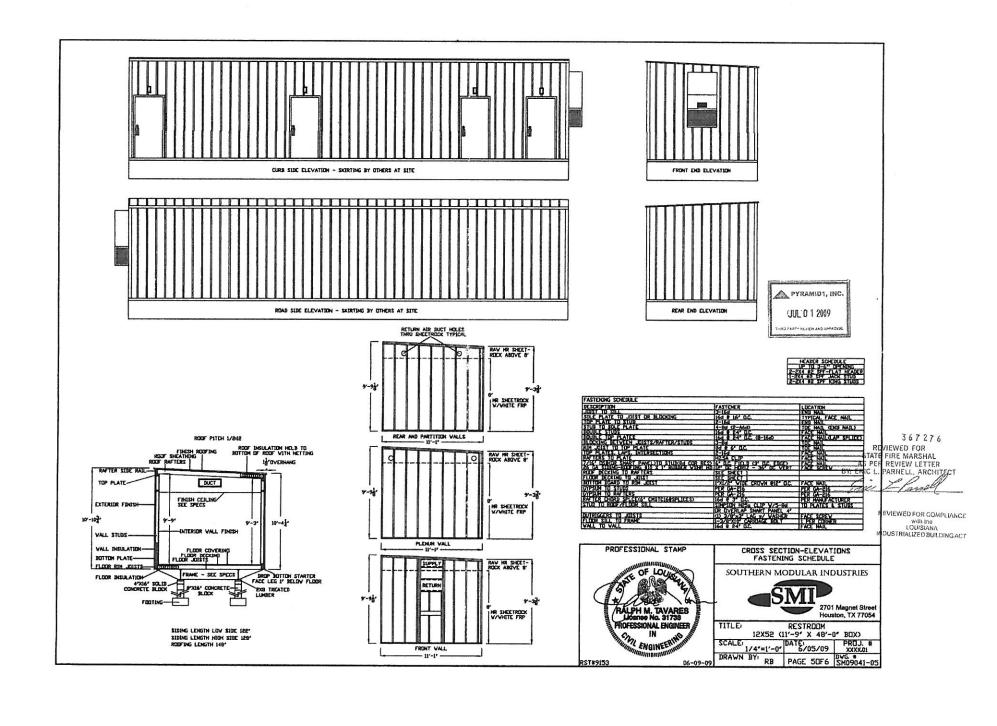

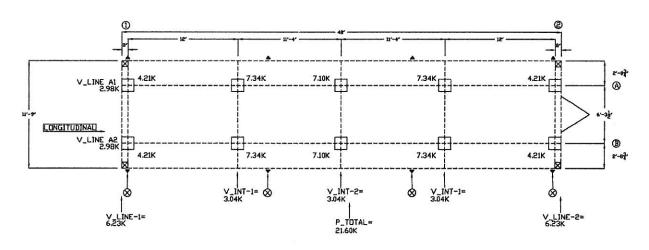


#### LEGEND

PROVIDE DVER-ROOF STRAP (I 1/2'XI6GA, Fy=33ks) @ 11'-4' D.C. MAX ALONG THE LONGITUDINAL DIRECTION. (4) STRAPS TOTAL AND CONNECTED TO FOUNDATION TIEDDWN

### NOTES:

- 1. SHADED PIERS (IF SHOWN) REQUIRE ADDITIONAL BLOCKING TO BOTTOM OF FLOOR JOISTS
- 2. SOUTHERN MODULAR INDUSTRIES, LP ASSUMES NO RESPONSIBILITY FOR ACTUAL FOUNDATION DESIGN AND/OR CONSTRUCTION.
- 3. CRAVL SPACE AREA TO BE VENTILATED AT 1 S.F. PER EACH 150 S.F. OF CRAVL SPACE AREA.
- 4. THIS IS A SUGGESTED PLAN ONLY, FOUNDATION TO BE DESIGNED BY A PROFESSIONAL ENGINEER PER LOCAL SOIL AND CLIMATIC CONDITIONS.
- 5. PROVIDE POSITIVE UNDER DRAINAGE MIN. 4' PEA GRAVEL AND 6 MIL POLYETHYLENE.
- 6. PROVIDE MINIMUM 22' X 24" ACCESS TO CRAVL SPACE AREA.
- 7. MINIMUM FOOTING DEPTH DETERMINED BY LOCAL SITE CLIMATIC REQUIREMENTS.
- 8. PIERS IN AXLE AREA MAY REQUIRE REMOVAL OF FRAME RUNNING GEAR.
- 9. KIP LOADS BASED ON MINIMUM 3,000% LOAD BEARING SOIL.



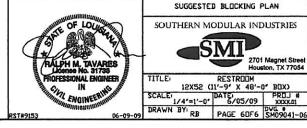

# SOUTHERN MODULAR INDUSTRIES

24X36 RESTROOM 23'-6" X 32'-0" ACTUAL SIZE 752 SQUARE FEET OCCUPANT LOAD: 18 BUILDING LOCATION LA - TX - OK SHIPPING HEIGHT = 13'-9"

1.71

- MATCHING 26 GAUGE STEEL TBD OPTIONAL SHIP LOOSE IN SHEETS

RODE RAFTERS: -----

-(6) 3/0 X 6/8 HM 20 GAUGE STEEL WITH 16 GAUGE FRAME, FLUSH, CLUSURE, DEAD BOLT, PUSH PULL PLATES, ADA THRESHOLD AND WEATHER STRIP EXTERIOR DODRS-

ELECTRICAL SERVICEI LUAD CENTERI ENTRANCEI RACEVAYI 120/240 VOLT SINGLE PHASE, 3 WIRE, 60 HZ. WITH GROUND
(1) 200 AMP HAIN MAIN BREAKER NEMA 3 EXTERIOR TYPE
2' CONDUIT
MINIMUM #12 AWG, COPPER W/GROUND IN EMT AND/OR MC CABLE (6) 4 TVO TUBE T8 TROFFER FLUBURESCENT TYPE
(2) 4 TVO TUBE T8 TROFFER FLUBURESCENT TYPE
(4) WP EXTERIOR VANDAL RESISTANT VITH 30 VATT FLUDRESCENT BULB
(2) SINGLE FACE EXIT LIGHT VITH BATTERY BACKUP RECEPTACLES.

(8) 120 VOLT 20 AMP WHITE GFIC TYPE

(1) 120 VOLT 20 AMP WHITE GFIC TYPE - EXTERIOR WP MOUNT

(8) 120 VOLT 15 AMP WHITE TOGGLE TYPE SWETCHES: --- (4) 120 VOLT ADA COMPLIANT SURFACE MOUNT HAND DRYER (5) 1-1/2' X 12' PVC CAPPED PIPING PER PRINT

PLUMBING:
SUPPLY LINES:
WASTE LINES:
WATER HEATER:
WATER CLOSET: CPVC
PVC DWV-SCH 40 DRAIN-WASTE-VENT LINES (CONCEALED) STUBBED THRU FLOUR
10 120 VOLT 20 GALLON TANK TYPE WITH TAP VALVE AND METAL IDRAIN PAN
15) WHITE CHINA TANK TYPE WITH AND ALDINGATED BOWL & DPEN FRONT SEAT
19) WHITE CHINA TANK TYPE WITH ELDNGATED BOWL & OPEN FRONT SEAT
10) WHITE CHINA WALL HUNG WITH FLUSH VALVE
10) WHITE CHINA 20X17 WALL HUNG WITH LEVER FAUCET
10) PLASTIC MOP SINK WITH GOISENECK LEVER FAUCET
10) FLASTIC MOP SINK WITH GOISENECK LEVER FAUCET
10) SET UF GRAB BARS - (10) 18' X 36' MIRRUR WITH CLIPS
10) LAVATORIES EQUIPPED WITH ADA INSULATED PIPE WRAPS
11 TOFF VALVES AT FIXTURES
17) FLOOR BRAIN WITH AUTOMATIC TRAP PRIMER
14) TOTHET PAPER HOLDERS
11 STEEL MODESTY PARTITIONS AND URINAL SCREENS

ACCESSURIES -

MISCO

STEEL MODESTY PARTITIONS AND URINAL SCREENS

BUILDING CODE NOTES:

- 1. 15/32' CDX 24' RATED SHEATHING SHALL BE SUFFICIENT FOR STRUCTURAL SHEER WALL REQUIREMENTS AT FASTENING SCHEDULE.
- 2. BLOCKING AND ANCHORING BELOW FRAME BY DITHERS.
- 3. DEALER SHALL BE RESPONSIBLE FOR ON SITE BARRIER FREE PROVISIONS, STEPS, RAMPS, PARKING SIGNS, ETC BUILDING APPROACH (WALK OR RAMP) WITH A MINIMUM WIDTH OF 5' AND A GRADUENT OF NOT LESS THAN 1 FOOT IN 20 FEET.
- 4. ALL LOCKS TO BE UNLOCKABLE FROM THE INTERIOR WITHOUT THE USE OF A KEY OR SPECIAL KNOWLEDGE.
- 5. CORROSION RESISTANCE FLASHING AT TOP AND SIDES OF DOORS, WINDOWS AND AT ROOF PENETRATIONS.
- 6. ALL GLAZING WITHIN 24' DF EXTERIOR PASSAGE DOORS AND INTERIOR PASSAGE DOORS IR WITHIN 18' OF FLOOR TO BE "SAFETY GLAZED" AND SO HARKED.

DATA PLATE IS ATTACHED IN VICINITY OF THE ELECTRICAL PANEL. STATE LABEL (IF APPLICABLE) IS AFFIXED IN VICINITY OF THE ELECTRICAL PANEL.

ELECTRICAL PAREL.

SPECIAL COMBITIONS/LIMITATIONS()
BUILDING GOOD FOR IECC ZONE 1 THRU 7.

FIRE ALARM SYSTEM IF REQUIRED BY LOCAL TO BE PROVIDED AND INSTALLED BY DITHERS AT SITE PER LOCAL CODE REGULATIONS. IBC PER SECTION 1609.14 EXCEPTION - 7/16' GSB COVER PANELS FOR VINDOWS TO BE SUPPLIED AT SITE BY OTHERS. BOTTLE WATER COOLER CS) PROVIDED AT SITE BY OTHERS. MOP SINK PROVIDED AT SITE BY OTHERS.

BUILDING CIDE NOTES
THE JOB SPECIFICATIONS SUPERFEDE THE DETAIL SPECIFICATIONS WHERE
THERE IS A CONFLICT, BUILDING TO BE LOCATED MINIMUM 20' FROM EXISTING
PROPERTY LINE, BUILDINGS ON THE SAME PROPERTY SHALL BE ASSUMED TO
HAVE A PROPERTY LINE BETWEEN THEM: THE BUILDING EXTERIOR AND THE
FACILITIES WITHIN THE BUILDING SHALL BE INDENTIFIED WITH THE
INTERNATIONAL SYMBOL OF ACCESSIBILITY (BY DITHERS).

Sec. 12

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3/6	ELECTRICAL PLAN	1/22/09
4/6	MECHANICAL - PLUMBING SCHEMATICS	1/25/09
5/6	CRUSS SECTION - ELEVATIONS - FASTENING - DETAILS	1/22/09
6/6	SUGGESTED BLOCKING PLAN	1/22/09

DESIGN PARAMETERS
OCCUPANCY GROUP B CONSTRUCTION TYPE VB

DESIGN CRITERIA POOF LIVE LOAD. ROOF DEAD LOAD 10 PSF FLOOR LIVE LOADS 50 PSF 10 PSF WIND HORIZONTAL: 130 MPH, EXPOSURE 'C' 3sg SEISMIC ZONE: Ss=0.919g S1=0.276g SEISMIC DESIGN CAT D, SITE CLASS D SEISMIC GROUP 3

LOUISIANA CODES
2005 NATIONAL ELECTRICAL CODE
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TEXAS CODES
2008 NATIONAL ELECTRICAL CODE
2006 INTERNATIONAL BUILDING CODE
2006 INTERNATIONAL MECHANICAL CODE
2006 INTERNATIONAL PLUMBING CODE 2006 INTERNATIONAL FUEL & GAS CODE 2006 INTERNATIONAL ENERGY CONSERVATION CODE 1994 TEXAS ACCESSIBILITY STANDARDS

OKLAHOMA CODES 2005 NATIONAL ELECTRICAL CODE 2006 INTERNATIONAL BUILDING CODE 2006 INTERNATIONAL MECHANICAL CODE 2006 INTERNATIONAL PLUMBING CODE 2006 INTERNATIONAL FUEL & GAS CODE NFPA 101-2000 ADAGE







COVER - SPECIFICATIONS

SOUTHERN MODULAR INDUSTRIES



M SPACE HOLDINGS 24X36 (23'-6" X 32'-0" BOX) OFFICE SCALE: 1/4'=1'-0' DATE: PRIJ. # xxxx.01.02 DRAWN BY RB PAGE 10F6 SM09006-01

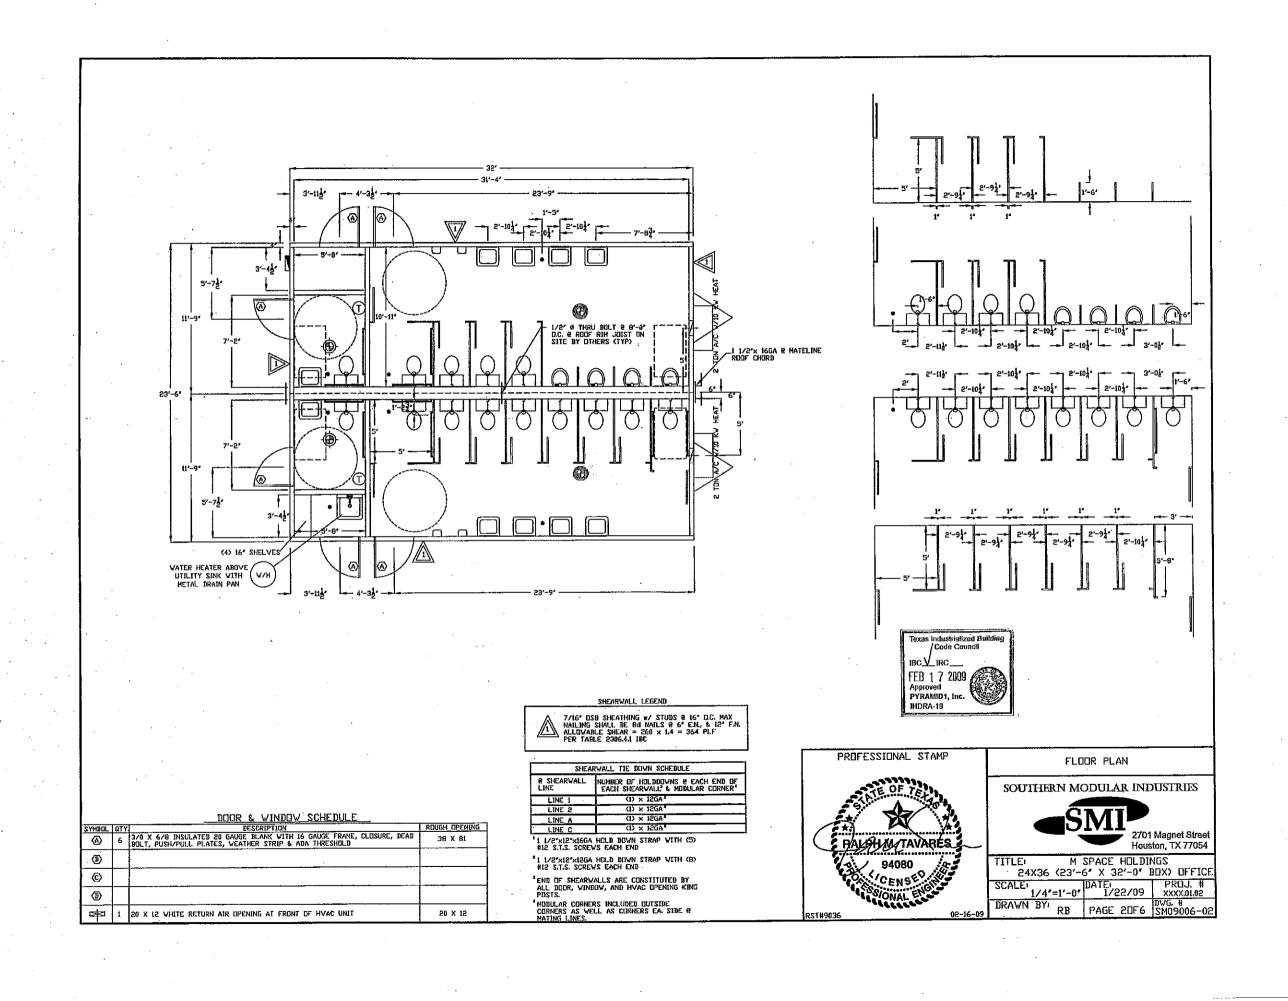

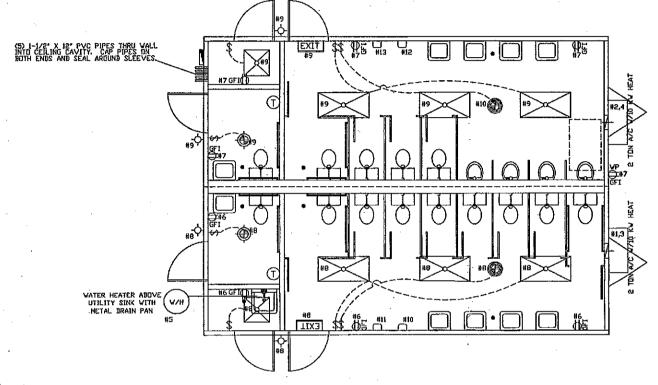

	ICAL CALCS			احييب	BREAKER	CALC'I
CIRCUIT	T# DEVICE		VATTS	X'S	SIZE	WATT:
1,3	HVAC	1	10,000	1.25	60A-2P	12,500
2,4	HVAC	1	10,000	1,25	60A-2P	12,500
5	HVH	1	1,500	1.25	20A-1P	1,875
6	RECEPT	4	180	1.00	20A-1P	720
7	RECEPT	5	180	1.00	20A-1P	900
88	LIGHT	3	64	1.25	15A~1P	240
	LIGHT	1	32	1.25	15A-1P	40
	FAN/LITE	1	120	1.25		150
	EXH FAN	1	180	1.25		225
	O/S LITE	5	30	1.25		76
	EXIT	1	15	1.25		19
9	LIGHT	3	64	1.25	15A-1P	240
	LIGHT	1	32	1,25		40
	FAN/LITE	1	120	1.25	:	150
	EXH FAN	1	180	1.25		225
	O/S LITE	5	30	1.25		76
	EXIT	1	15	1.25		19
10	HD DRYER	1	1,200	1.00	15A-1P	1,200
11	HD DRYER	1	1,200_	1.00	_15A-1P_	1,200
12	HD DRYER	1	1,200	1.00	15A-1P	1,200
13	HD DRYER	1	1,200	1.00	15A-1P	1,200
TOTAL \	ZTTAW					34,79
TOTAL A	AMPS (WATTS/	<b>240</b>	V)			145.0



1				
SYNBOL	QTY.	DESCRIPTION		
===	1	200 AMP - 120/240V - SINGLE PHASE - NEMA 3 - ELECTRICAL PANEL		
	6	4' 2-TUBE FLUDRESCENT TO TROFFER LIGHT VITH ELECTRONIC DALLAST (48" TO BE 32 VATT, FIXTURE WATTAGE 64 VATTS)		
	2	4' 4-TUBE FLUGRESCENT TB TROFFER LIGHT WITH ELECTRONIC BALLAST (48" TB EB 32 VATT, FIXTURE WATTAGE 32 WATTS)		
<b>₩</b>	4	30 VATT FLUCKESCENT WP EXTERIOR LIGHT ON PHOTO CELL		
EXIT	5	EXIT LIGHT WITH BATTERY BACKUP		
<b>(</b>	5	COMBINATION 75 CFM CEILING FAN/LIGHT DUCTED THRU ROOF WITH CAP		
(A)		350 CFM CEILING EXHAUST DUCTED THRU ROOF WITH CAP		
\$	8	120V 15 AMP WHITE TOGGLE SWITCH		
∌	9	120V 15 AMP WHITE DUPLEX RECEPTACLE GROUNDING TYPE		
GFIQUP 1 120V 80 AND WHITE GFIC RECEPTACLE EXTERIOR MOUNT WITH		120V 20 ANP WHITE GFIC RECEPTACLE		
		120V 80 AMP WHITE GFIC RECEPTACLE EXTERIBR MOUNT WITH WP COVER		
①	2	PRUGRAMABLE THERMOSTAT (5/2)		

PANEL 120/240V SINGLE PHASE 3-VIRE NEMA 3-R TO BE MARKED AS APPROVED FOR USE AS SERVICE EQUIPMENT.

#6 BARE GROUND WIRE FROM GROUNDING LUG IN PANEL BOX TO GROUNDING BOLT ON FRAME.

MAIN DISTRIBUTION PANEL SUPPLIED AND INSTALLED AT SITE BY OTHERS.

2' PVC CONDUIT FOR SITE FEEDERS BY OTHERS - ALL CONNECTIONS HADE AT SITE BY OTHERS

<u> </u>	
COPPER WIRE	SIZE
CIRCUIT SIZE	WIRE SIZE (W/GRD)
15 AMP	#14
20 AMP	#12
30 AMP	#10
40 AMP	#8
60 AMP	#6
LEO AMP	l ao i

THE CIRCUIT NUMBERS SHOWN DO NOT MECESSARILY DENOTE THE ACTUAL CIRCUIT NUMBERS BUT ARE INTENDED TO DISIGNATE CIRCUITS.

ENT CONDUIT REQUIREMENTS
ALL CONDUCTORS TO BE MINIMUM 90 DEGREE C RATED.
MAKINUM OF (4) FOUR IS AMP CIRCUITS PER 1/2' ENT CONDUIT.
MAKINUM OF (3) THREE 80 AMP CIRCUITS PER 1/2' ENT CONDUIT.
ALL OTHER AMPERAGE CIRCUITS TO BE RUN SEPARATELY IN
MINIMUM 3/4' ENT CONDUIT.




ELECTRICAL PLAN


SOUTHERN MODULAR INDUSTRIES



2701 Magnet Street Houston, TX 77054

1		SPACE HOLDIN 6' X 32'-0' I			
		DATE: 1/22/09			
,	DRAWN BYI RB	PAGE 3UF6	DL/C #		

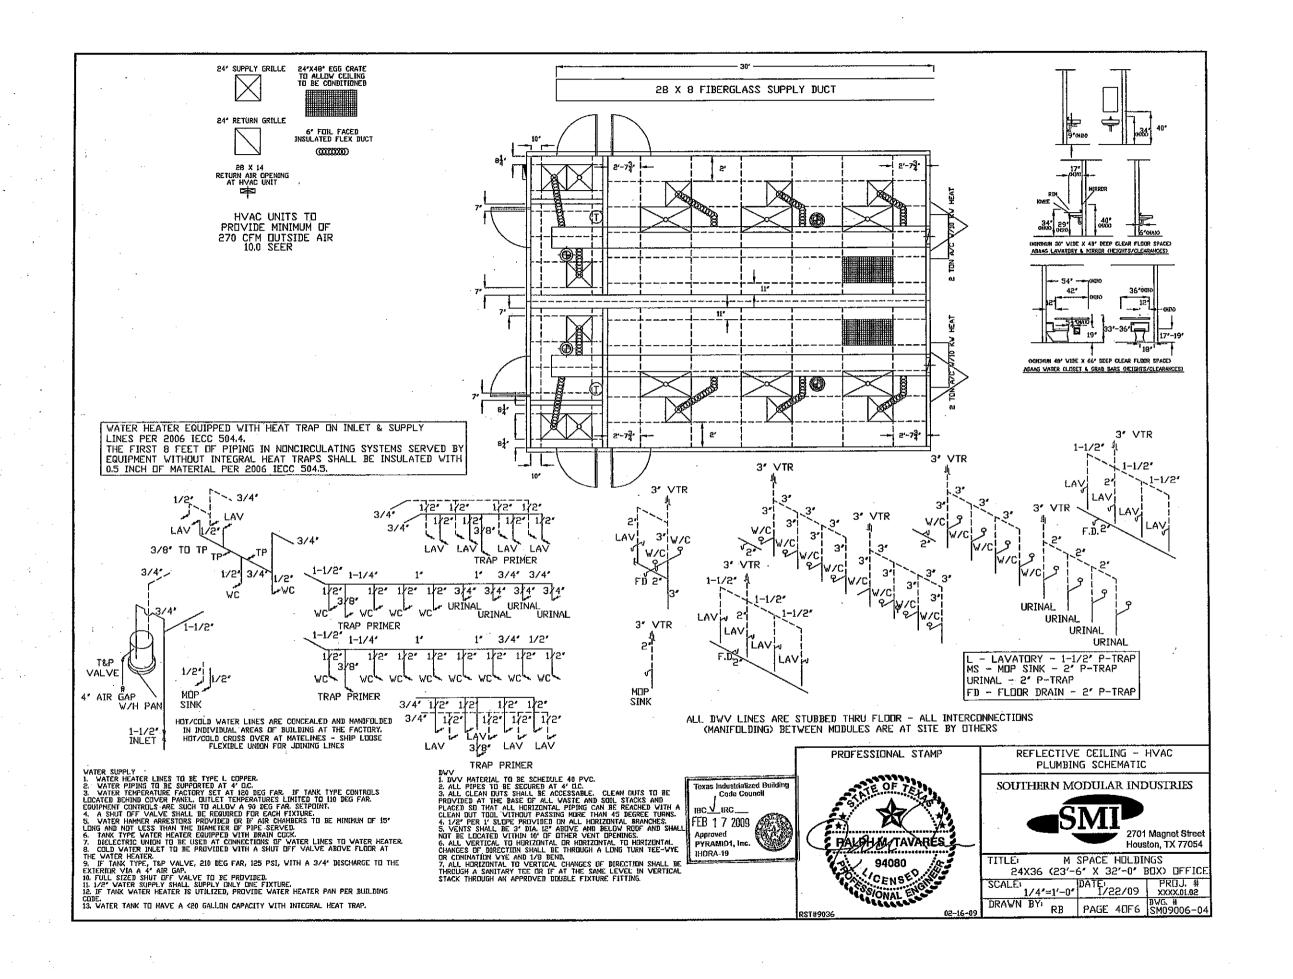

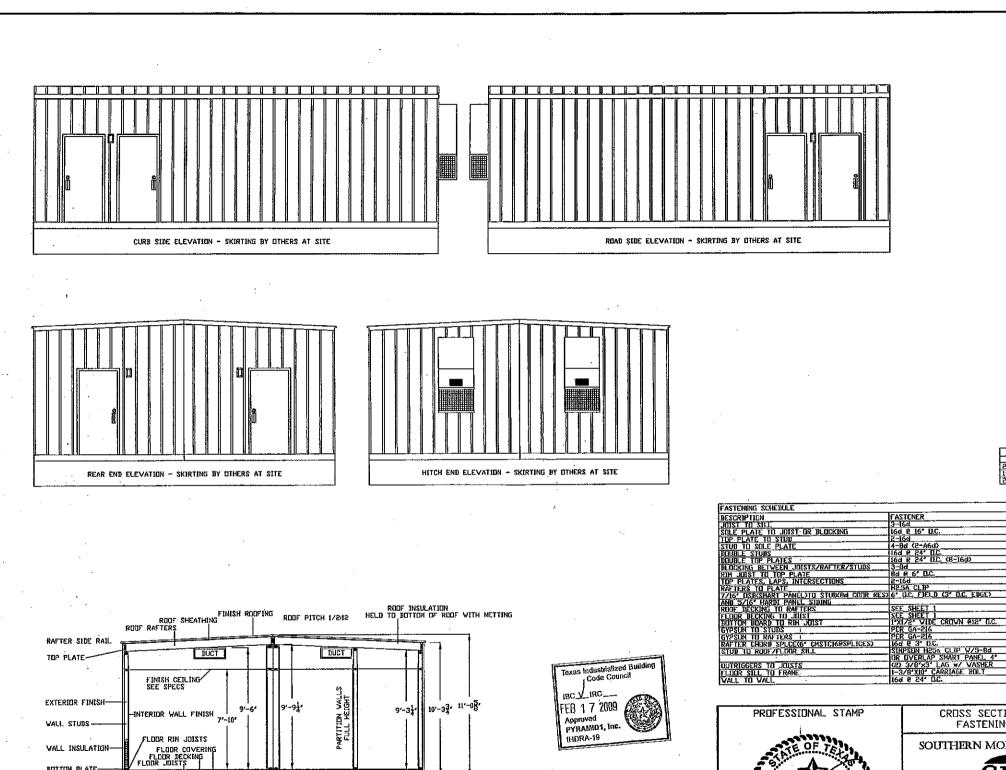

FRAME - SEE SPECS HULB UP BOTTOM STARTER 1' FACE LEG 1' BELOV FLOOR

STEEL SIDING TO MATELINE

STANDARD J-TRIM CAP @ MATELINE

MATELINE CLOSE UP DETAIL

3" HEMMED CAP (SHIP LODSE FOR CLOSE OFF AT SITE)


8'X16' CONCRETE BLOCK

BOTTOM PLATE-


FLOOR INSULATION

2X8 TREATED

4'XI6' SOLID CONCRETE BLOCK

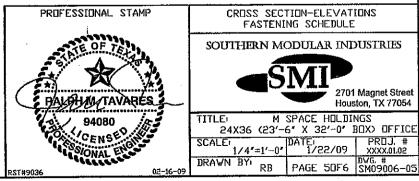

LUCATION
END NAIL
TYPICAL FACE NAIL
END NAIL
TOE NAIL (END NAIL)
FACE NAIL
FACE NAIL
TOE NAIL
TOE NAIL
TOE NAIL
FACE NAIL
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FACE NAIL
FACE NAIL
FACE NAIL

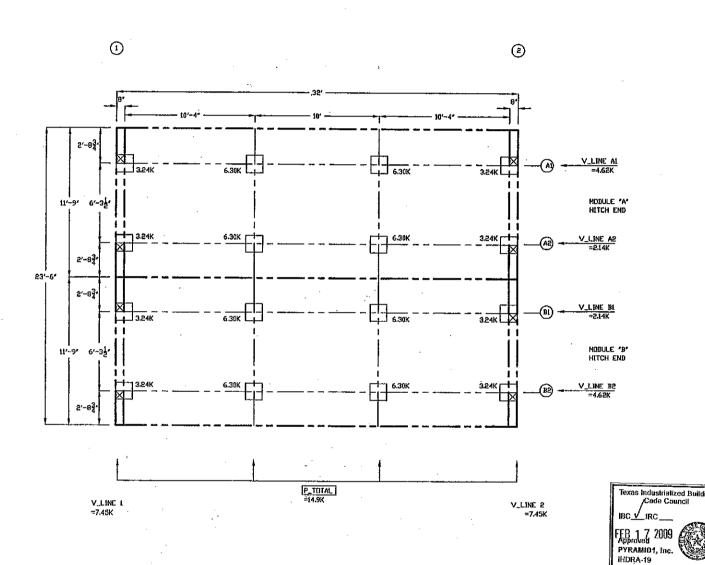

NOTES

- 1. SHADED PIERS (IF SHOWN) REQUIRE ADDITIONAL BLOCKING TO BOTTOM OF FLOOR JOISTS
- 2. SOUTHERN MODULAR INDUSTRIES, LP ASSUMES NO RESPONSIBILITY FOR ACTUAL FOUNDATION DESIGN AND/OR CONSTRUCTION.
- 3. CRAWL SPACE AREA TO BE VENTILATED AT 1 S.F. PER EACH 150 S.F. OF CRAWL SPACE AREA.
- 4. THIS IS A SUGGESTED PLAN ONLY, FOUNDATION TO BE DESIGNED BY A PROFESSIONAL ENGINEER PER LOCAL SOIL AND CLIMATIC CONDITIONS.
- 5. PROVIDE POSITIVE UNDER DRAINAGE MIN. 4' PEA GRAVEL AND 6 MIL POLYETHYLENE.
- 6. PROVIDE MINIMUM 22" X 24" ACCESS TO CRAWL SPACE AREA.
- 7. MINIMUM FUUTING DEPTH DETERMINED BY LUCAL SITE CLIMATIC REQUIREMENTS.
- B. PIERS IN AXLE AREA MAY REQUIRE REMOVAL OF FRAME RUNNING GEAR.
- 9. KIP LUADS BASED ON MINIMUM 3,000# LOAD BEARING SOIL.



SUGGESTED BLOCKING PLAN

SOUTHERN MODULAR INDUSTRIES



2701 Magnet Street Houston, TX 77054

	TITLE: M	SPACE HOLD:	INGS
	24X36 (23'-	6" X 32'-0"	BOX) OFFICE
	SCALE: 1/4"=1'-0"	DATE: 1/22/09	PROJ # XXXX.01.02
-09	DRAWN BYI RB	PAGE 60F6	DWG. #

# ERAME. I-BEAH: CRUSSHEMBER: 48° D.C. ASTM A-529 FORMED STEEL CRUSSHEMBER: 48° D.C. ASTM A-529 FORMED STEEL - 75-1/2° DUTRIGGER: 48° D.C. ASTM A-529 FORMED STEEL - 31-3/4° HITCH: BEMDINTABLE WITH 2-5/16' CDUPLER & ELEVATING JACK AXLES: TREPLE 6000H (2 BRAKE - 1 IDLER/HODULE) - 75-1/2° S.C. TIRES: 800 X 14.5 X 10 PLY PAINT: MINIMUM 3 MIL BLACK ASPHALT

EXTERIOR VALLS

STUDS:

2X4 #2 SYP DR EQUAL @ 16' CC.

(NOTE: THE STUDS ARE DOUBLED @ 16' CC FIRST 5' AT FRONT AND BACK CORNER)

BOTTOM PLATE:

SINGLE 2X4 #2 SYP

VALL HEIGHT:

VALL COVERING:

1/2' VINYL COVERED GYPSUM - SMI STANDARD

INSULATION:

R-13 KRAFT FACED FIBERGLASS

SHEATHING:

7/16' DSB RATED 24' PER NER-124 & FULL HOUSEVRAP

SEE SHEARWALL TYPE PAGE 2

SIDING:

26 GAUGE HI RIB STEEL TED OPTIONAL SHIP LOOSE IN SHEETS INTERIOR WALLS

-(6) 3/6 x 6/8 HM 20 GAUGE STEEL WITH 16 GAUGE FRAME, FLUSH, CLUSURE, DEAD BOLT, PUSH PULL PLATES, ADA THRESHOLD AND

	WEATHER STRIP
ELECTRICAL	•
SERVICE:	120/240 VOLT SINGLE PHASE, 3 VIRE, 60 HZ. VITH GROUND
LOAD CENTER	(1) 200 AMP MAIN MAIN BREAKER NEMA 3 EXTERIOR TYPE
ENTRANCE:	
RACEWAY:	MINIMUM #12 AWG, COPPER W/GROUND IN EMT AND/OR MC CABLE
LIGHTS:	(6) 4' TWO TUBE TO TROFFER FLUDURESCENT TYPE
	(2) 4' TVD TUBE TO TROFFER FLUDURESCENT TYPE
	(4) WP EXTERIOR VANDAL RESISTANT WITH 30 WATT FLUORESCENT BULB
	(2) SINGLE FACE EXIT LIGHT WITH BATTERY BACKUP
RECEPTACLES:	-(8) 120 VOLT 20 AMP WHITE GFIC TYPE
	(1) 120 VOLT 20 AMP WHITE GFIC TYPE - EXTERIOR WP MOUNT
SWITCHES:	(8) 120 VOLT 15 AMP WHITE TOGGLE TYPE
MISC:	(4) 120 VOLT ADA COMPLIANT SURFACE MOUNT HAND DRYER
	(5) 1-1/2" X 12" PVC CAPPED PIPING PER PRINT
PLUMBING:	
SUPPLY LINES:	- CPVC
WASTE LINES:	- PVC DWV-SCH 40 DRAIN-WASTE-VENT LINES (CONCEALED) STUBBED THRU FLOOR
WHILK HEALEK!	UD 120 VIII.I 20 SALLUN TANK TYPE WITH TOD WALVE AND NETAL BOATS DAN
WATER CLOSET:	(5) WHITE CHINA TANK TYPE WITH ANA FIGNGATED BOOK & DOEM FORMY SEAT
	VOLUMENTE, CHINA IANK IYPE WITH FITNGATED DOLL & DDEN CODNIT COAT
UKINALI	(4) WHITE CHINA WALL HUNG WITH FLUSH VALVE
LAVAIDALI	(10) WHITE CHINA 20X17 WALL HUNG WITH LEVER FAUCET (1) PLASTIC MIP SINK WITH GODSENECK LEVER FAUCET
ACCESSORIES	(5) SET OF GRAB BARS - (10) 18" X 36" MIRROR WITH CLIPS
HOCEGODKIESI	LAVATORICE FOUNDED LITTLE AND ANDREAS WITH CLIPS
MISC:	LAVATORIES EQUIPPED WITH ADA INSULATED PIPE WRAPS SHUT OFF VALVES AT FIXTURES
	(7) FLOOR DRAIN WITH AUTOMATIC TRAP PRIMER
	(14) TOILET PAPER HOLDERS
	STEEL MODESTY PARTITIONS AND URINAL SCREENS
H.V.A.C.	THE PROPERTY OF THE STATE OF TH

H.V.A.C, HEATING: ------CUULING UNIT: -----

SOUTHERN MODULAR INDUSTRIES

24X36 RESTROOM 23'-6" X 32'-0" ACTUAL SIZE 752 SQUARE FEET OCCUPANT LOAD: 18 BUILDING LOCATION: LA - TX - OK SHIPPING HEIGHT = 13'-9"

#### BUILDING CODE NOTES:

- 15/32' CDX 24" RATED SHEATHING SHALL BE SUFFICIENT FOR STRUCTURAL SHEER WALL REQUIREMENTS AT FASTENING SCHEDULE.
- 2. BLOCKING AND ANCHORING BELOW FRAME BY OTHERS.
- 3. Dealer Shall be responsible for on site barrier free Provisions, Steps, Ramps, Parking Signs, etc. Building Approach (Valk or Ramp) vith a minimum vidth of 5' and a Gradient of Not Less than 1 foot in 20 feet.
- 4. ALL LOCKS TO BE UNLOCKABLE FROM THE INTERIOR VITHOUT THE USE OF A KEY OR SPECIAL KNOWLEDGE.
- 5. CORROSION RESISTANCE FLASHING AT TOP AND SIDES OF DOORS, WINDOWS AND AT ROOF PENETRATIONS.
- 6. ALL GLAZING WITHIN 24' CF EXTERIOR PASSAGE DOORS AND INTERIOR PASSAGE DOORS OR WITHIN 18' OF FLOOR TO BE "SAFETY GLAZED" AND SO MARKED.

DATA PLATE IS ATTACHED IN VICINITY OF THE ELECTRICAL PANEL. STATE LABEL (IF APPLICABLE) IS AFFIXED IN VICINITY OF THE ELECTRICAL PANEL.

SPECIAL CONDITIONS/LEMITATIONS
BUILDING GOIDD FOR IECC ZONE I THRU 7.
FIRE ALARM SYSTEM IF REQUIRED BY LOCAL TO BE PROVIDED AND
INSTALLED BY OTHERS AT SITE PER LOCAL CODE REGULATIONS.
IBC PER SECTION 1609.14 EXCEPTION - 7/16' ISB COVER PANELS FOR
WINDOWS TO BE SUPPLIED AT-SITE BY OTHERS.
BUTTLE WATER CODLER (S) PROVIDED AT SITE BY OTHERS.
BUTTLE WATER CODLER (S) PROVIDED AT SITE BY OTHERS. MOP SINK PROVIDED AT SITE BY OTHERS.

BUILDING CODE NOTES
THE JOB SPECIFICATIONS SUPERCEDE THE JOB SPECIFICATIONS WHERE
THERE IS A CONFLICT, BUILDING IN THE LOCATED MINIHUM 20' FROM EXISTING
PROPERTY LINE, BUILDINGS ON THE SAME PROPERTY SHALL BE ASSUMED TO
HAVE A PROPERTY LINE BETVEEN THEM. THE BUILDING EXTERIOR AND THE
FACILITIES WITHIN THE BUILDING SHALL BE INDENTIFIED WITH THE
INTERNATIONAL SYMBOL OF ACCES, VBILITY (BY OTHERS).

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TITLE	DVG DATE
COVER-SPECIFICATIONS	1/22/09
BUILDING FLOOR PLAN	1/22/09
ELECTRICAL PLAN	1/22/09
MECHANICAL - PLUMBING SCHEMATICS	1/22/09
CROSS SECTION - ELEVATIONS - FASTENING - DETAILS	1/22/09
SUGGESTED BLOCKING PLAN	1/22/09
	COVER-SPECIFICATIONS  BUILDING FLUIR PLAN  ELECTRICAL PLAN  MECHANICAL - PLUMBING SCHEMATICS  CRUSS SECTION - ELEVATIONS - FASTENING - DETAILS

DESIGN PARAMETERS
DCCUPANCY GROUP B
CONSTRUCTION TYPE VB

DESIGN CRITERIA ROOF LIVE LOAD 20 000 ROOF DEAD LOAD 10 PSF FLOOR LIVE LOAD FLOOR DEAD LOAD: 10 PSF WIND HORIZONTAL: 130 MPH, EXPOSURE "C" 350 SEISMIC ZONE: Ss=0.919g SI=0.276g
SEISMIC DESIGN CAT B, SITE CLASS D SEISMIC GROUP 3

LIUISIANA CODES
2005 NATIONAL ELECTRICAL CODE
2006 INTERNATIONAL BUILDING CODE (EXCLUDING
CHAPTERS 1, 11, 27 AND 29)
2006 INTERNATIONAL MECHANICAL CODE
2006 LOUISIANA STATE PLUMBING CODE
2006 INTERNATIONAL FUEL & GAS CODE
2006 ENERGY CODE ASHRAE 90.1

TEXAS CODES 2008 NATIONAL ELECTRICAL CODE 2006 INTERNATIONAL BUILDING CODE 2006 INTERNATIONAL MECHANICAL CODE 2006 INTERNATIONAL PLUMBING CODE 2006 INTERNATIONAL FUEL & GAS CODE 2006 INTERNATIONAL ENERGY CONSERVATION CODE 1994 TEXAS ACCESSIBILITY STANDARDS

DKLAHOMA CIDES
2005 NATIONAL ELECTRICAL CIDE
2006 INTERNATIONAL BUILDING CIDE
2006 INTERNATIONAL MECHANICAL CIDE
2006 INTERNATIONAL MECHANICAL CIDE
2006 INTERNATIONAL PLUMBING CIDE 2006 INTERNATIONAL FUEL & GAS CODE





COVER - SPECIFICATIONS


SOUTHERN MODULAR INDUSTRIES




M SPACE HULDINGS 24X36 (23'-6" X 32'-0" BOX) OFFICE 1/4'=1'-0' DATE: XXXX.01.0S

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RST#9036



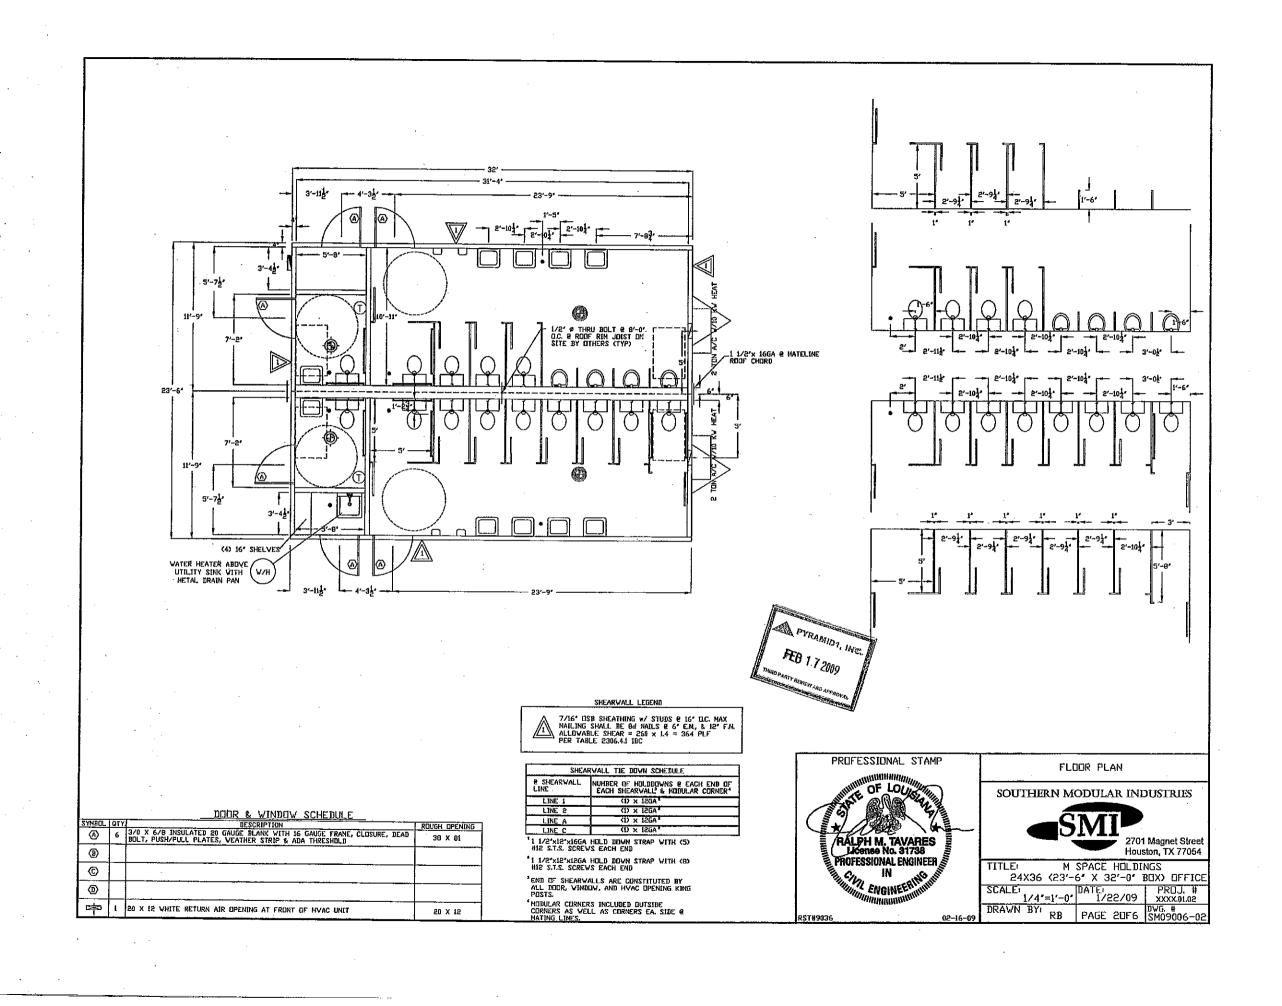

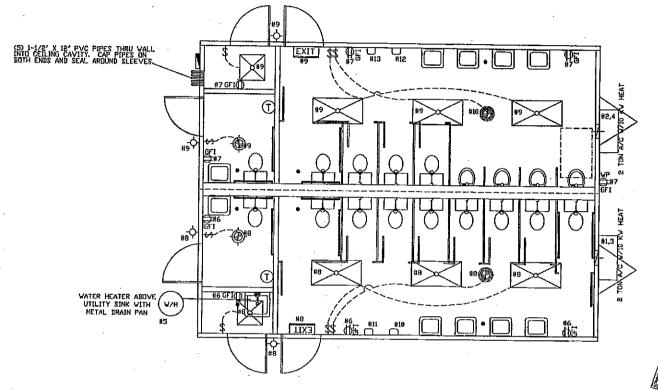ELECTRI	CAL CALCS				BREAKER	CALC'D
	DEVICE	TÖTY	WATTS	X'S	SIZE	ZTTAV
1,3	HVAC	Ť	10,000	1.25	60A-2P	12,500
2,4	HVAC	ī	10,000	1.25	60A-2P	12,500
5	HWH	1	1,500	125	20A-1P	1,875
6	RECEPT	4	180	1.00	20A-1P	720
7	RECEPT	5	180	1.00	20A-1P	900
8	LIGHT	3	64	1.25	15A-1P	240
	LIGHT	1	32	1.25	15A-1P	40
	FAN/LITE	1	120	1.25		150
	EXH FAN	1	180	1.25		225
	U/S LITE	2	30	1.25		76
	EXIT	1	15	1.25		19
9	LIGHT	3	64	1.25	15A-1P	240
Ľ	LIGHT	1	32	1,25		40
	FAN/LITE	1	120	1.25		150
· · ·	EXH FAN	1	180	1,25		225
	O/S LITE	2	30	1.25		76
	EXIT	1	15	1.25		19
10	HD DRYER	1	1,200	1.00	15A-1P	1,200
11	HD DRYER	1	1,200	1.00	15A-1P	1,200
12	HD DRYER	1	1,200	1.00	15A-1P	1,200
13	HD DRYER	1	1,200	1.00	15A-1P	1,200
J	l	II				
TOTAL WATTS					34,795	
TOTAL AMPS (VATTS/240V)				145.0		



SYNBOL	QTY.	DESCRIPTION
	1	200 ANP - 120/240V - SINGLE PHASE - NEMA 3 - ELECTRICAL PANEL
X	6	4' 2-TUBE FLUGRESCENT TO TROFFER LIGHT WITH ELECTRONIC BALLAST (48' TB EB 32 WATT, FIXTURE WATTAGE 64 WATTS)
$\boxtimes$	2	4' 4-TUBE FLUCRESCENT TO TROFFER LIGHT WITH ELECTRONIC BALLAST (48' TO EB 32 WATT, FIXTURE WATTAGE 32 WATTS)
ф	4	30 VATT FLUORESCENT WP EXTERIOR LIGHT ON PHOTO CELL
EXIT	2	EXIT LIGHT WITH BATTERY BACKUP
<b>(</b>	2	COMBINATION 75 CFM CEILING FAN/LIGHT DUCTED THRU RDDF WITH CAP
	5	350 CFM CEILING EXHAUST DUCTED THRU ROOF WITH CAP
\$.	8	120V 15 AMP WHITE TOGGLE SWITCH
₽	0	120V 15 ANP VHITE DUPLEX RECEPTACLE GROUNDING TYPE
GF1(I)	8	120V 20 AMP WHITE GFIC RECEPTACLE
GEI∰WP	i	120V 20 AMP WHITE GFIC RECEPTACLE EXTERIOR MOUNT WITH WP COVER
	4	ADA COMPLIANT SURRACE MOUNT HAND DRYER
T	2	PROGRAMABLE THERMOSTAT (5/2)

PANEL 120/240V SINGLE PHASE 3-WIRE NEMA 3-R TO BE MARKED AS APPROVED FOR USE AS SERVICE EQUIPMENT.

M6 BARE GROUND WIRE FROM GROUNDING LUG IN PANEL BOX TO GROUNDING BOLT ON FRAME.

MAIN DISTRIBUTION PANEL SUPPLIED AND INSTALLED AT SITE BY DITHERS. 2' PVC CONDUIT FOR SITE FEEDERS BY OTHERS - ALL CONNECTIONS MADE AT SITE BY OTHERS

ELECTRICAL PANEL RISER DIAGRAM

COPPER VIRE	SIZE	
CIRCUIT SIZE	WIRE SIZE (W/GRD)	
15 AMP	#14	
20 AMP	#15	
30 AMP	#10	
40 AHP	#9	
60 AMP	#6	
90 AMP	#2	

THE CIRCUIT NUMBERS SHOWN DO NOT MECESSARILY DENOTE THE ACTUAL CIRCUIT NUMBERS BUT ARE INTENDED TO DISIGNATE CIRCUITS.

EMT CONDUIT REQUIREMENTS


ALL CONDUCTURS TO BE MINIMUM 90 DEGREE C RATED.

MAXIMUM DF (4) FOUR 15 AMP CIRCUITS PER 1/2' ENT CONDUIT.

MAXIMUM DE (3) THREE 20 AMP CIRCUITS PER 1/2' ENT CONDUIT.

ALL OTHER AMPERAGE CIRCUITS TO BE RUN SEPARATELY IN

MINIMUM 3/4' EMT CONDUIT.

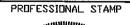



ELECTRICAL PLAN

SOUTHERN MODULAR INDUSTRIES



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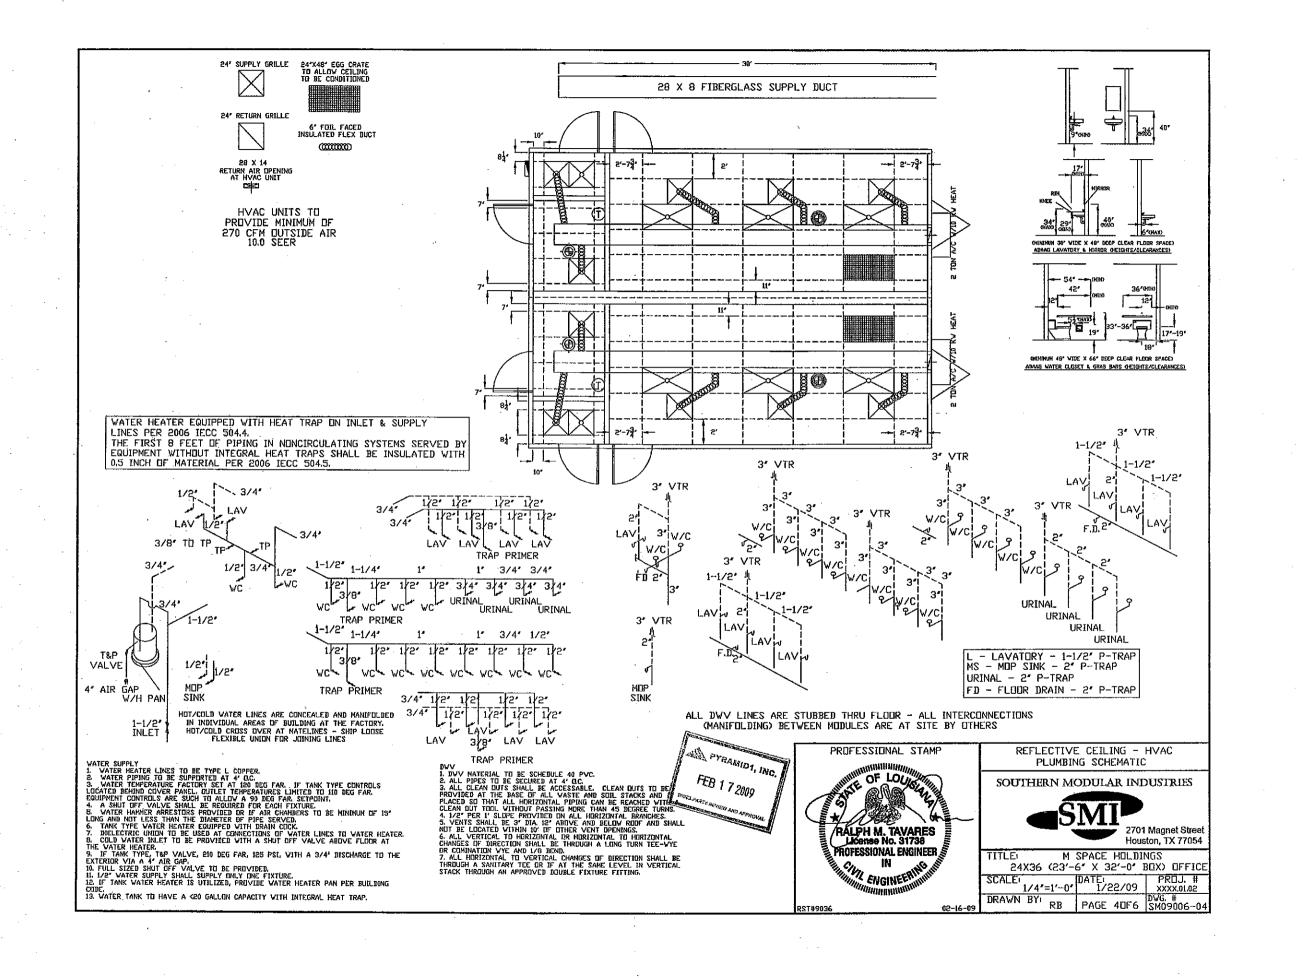
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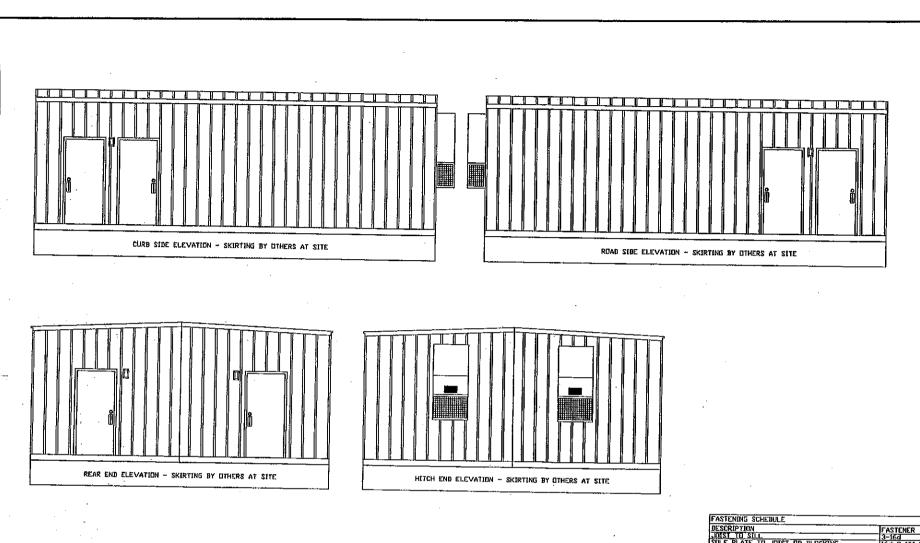
24X36 (23'-6' X 32'-0' BDX) DFFICE

SCALE: 1/4'=1'-0' 1/22/09 PRDJ. #


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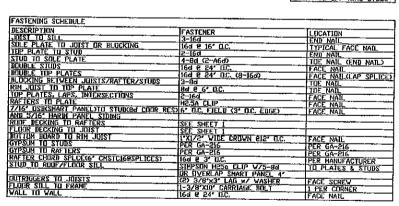
RST#9036










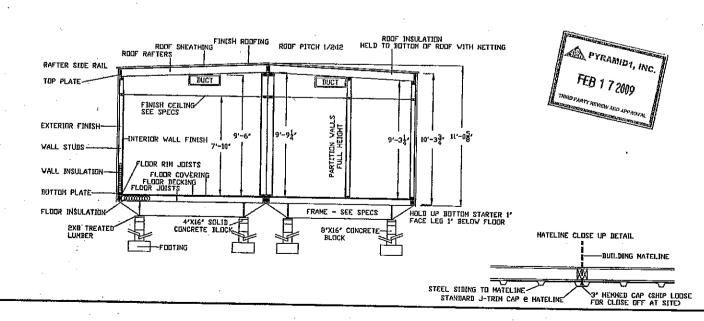

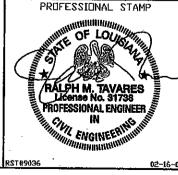

CROSS SECTION-ELEVATIONS FASTENING SCHEDULE

SOUTHERN MODULAR INDUSTRIES




2701 Magnet Street Houston, TX 77054

TITLE: M SPACE HOLDINGS
24X36 (23'-6' X 32'-0' BOX) OFFICE

SCALE: 1/4'=1'-0' DATE: 1/22/09 XXXX.0i.02

DRAWN BY: RB PAGE 50F6 SM09006-05

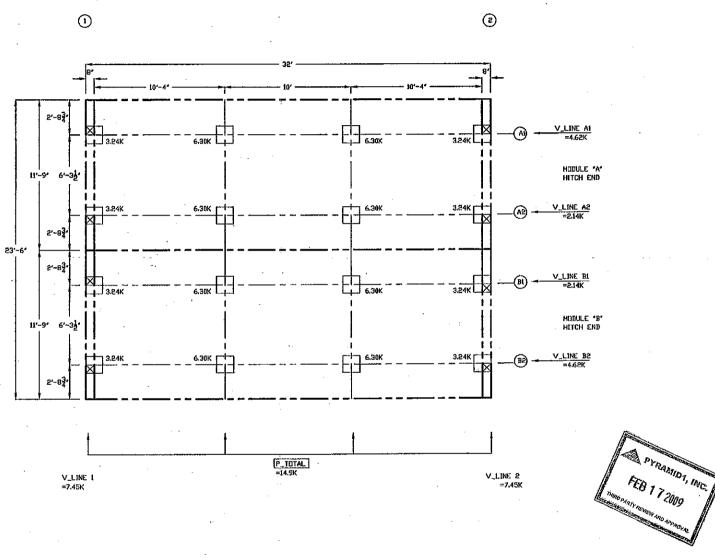

## NOTES:

- 1. SHADED PIERS (IF SHOWN) REQUIRE ADDITIONAL BLOCKING TO BOTTOM OF FLOOR JOISTS
- 2. SOUTHERN MODULAR INDUSTRIES, LP ASSUMES NO RESPONSIBILITY FOR ACTUAL FOUNDATION DESIGN AND/OR CONSTRUCTION.
- 3. CRAVL SPACE AREA TO BE VENTILATED AT 1 S.F. PER EACH 150 S.F. DF CRAVL SPACE AREA.
- 4. THIS IS A SUGGESTED PLAN ONLY, FOUNDATION TO BE DESIGNED BY A PROFESSIONAL ENGINEER PER LOCAL SOIL AND CLIMATIC CONDITIONS.
- 5. PROVIDE POSITIVE UNDER DRAINAGE MIN. 4' PEA GRAVEL AND 6 MIL POLYETHYLENE.
- 6. PROVIDE MINIMUM 22' X 24' ACCESS TO CRAWL SPACE AREA.
- 7. MINIMUM FOOTING DEPTH DETERMINED BY LOCAL SITE CLIMATIC REQUIREMENTS.
- 8. PIERS IN AXLE AREA MAY REQUIRE REMOVAL OF FRAME RUNNING GEAR.
- 9. KIP LOADS BASED ON MINIMUM 3,000# LOAD BEARING SOIL.



SUGGESTED BLOCKING PLAN

SOUTHERN MODULAR INDUSTRIES



TITLE: M SPACE HOLDINGS
24X36 (23'-6' X 32'-0' BOX) OFFICE

SCALE: PROJ #
1/4'=1'-0' 1/22/09 xxxx.01.02

TH9036 OS-16-09 SCALE: 1/4'=1'-0' 1/22/09 XXXX.01.02

DRAWN BY: RB PAGE 60F6 SM09006-06